
NORTHERN RIVERS RAIL TRAIL - BENTLEY TO LISMORE

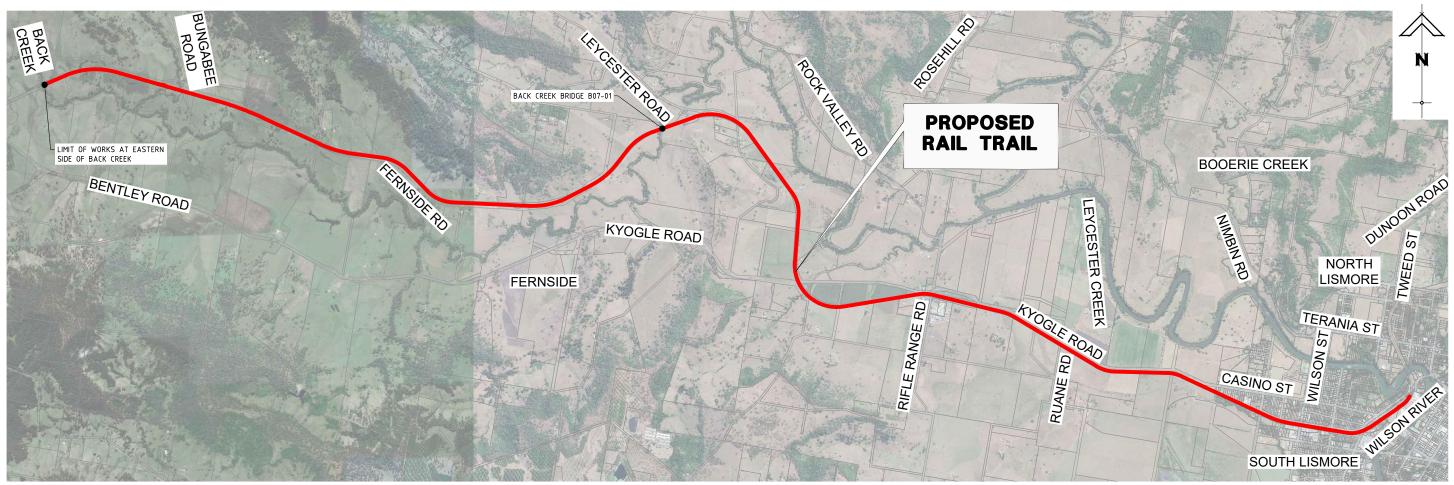

SCHEDULE OF DRAWINGS Drawing Title Drawing No.

C000	COVER SHEET AND DRAWING SCHEDULE
C100	GENERAL NOTES
C101	TYPICAL CROSS SECTIONS
C102	TYPICAL PAVEMENT DETAILS
C103	TYPICAL ROAD CROSSING DETAILS
C104	LOW LEVEL BYPASS WITH CULVERTS - TYPICAL DETAILS
C105	LOW LEVEL BYPASS WITH BRIDGE - TYPICAL DETAILS
C106	LOW LEVEL DECK TYPICAL DETAILS
C107	BRIDGE CROSSING DETAILS
C108	CHAIN LINK FENCE DETAIL
C200	RAIL TRAIL ALIGNMENT KEY PLAN
C201	PLAN - SHEET 1
C202	PLAN - SHEET 2
C203	PLAN - SHEET 3
C204	PLAN - SHEET 4
C205	PLAN - SHEET 5
C206	PLAN - SHEET 6
C207	PLAN - SHEET 7
C208	PLAN - SHEET 8
C209	PLAN - SHEET 9
C210	PLAN - SHEET 10
C211	PLAN - SHEET 11
C212	PLAN - SHEET 12
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C300	RAIL TRAIL ROAD, DRIVEWAY CROSSING KEY PLAN
C301	DRIVEWAY CROSSING PLAN - SHEET 1
C302	DRIVEWAY CROSSING PLAN - SHEET 2
C303	DRIVEWAY CROSSING PLAN - SHEET 3
C304	DRIVEWAY CROSSING PLAN - SHEET 4
C305	DRIVEWAY CROSSING PLAN - SHEET 5
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	SCHEDULE OF DRAWINGS			
Drawing No.	Drawing Title			
C307	DRIVEWAY CROSSING PLAN - SHEET 7			
C308	DRIVEWAY CROSSING PLAN - SHEET 8			
C309	PROPOSED SIGNAGE SCHEDULE			
C400	RAIL TRAIL BRIDGES KEY PLAN			
C401	BRIDGE B00-01 PLAN AND PROFILE			
C402	BRIDGE B00-01 CROSS SECTIONS - SHEET 1			
C403	BRIDGE B00-01 CROSS SECTIONS - SHEET 2			
C404	BRIDGE B00-02, B00-03, B01-01, B01-02 PLAN			
C405	BRIDGE B01-03, B02-01 PLAN			
C406	BRIDGE B02-02, B02-03 PLAN			
C407	BRIDGE B02-04 PLAN			
C408	BRIDGE B03-01 PLAN AND PROFILE			
C409	BRIDGE B03-01 CROSS SECTIONS - SHEET 1			
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C412	BRIDGE B05-01 PLAN			
C413	BRIDGE B07-01 PLAN AND PROFILE - SHEET 1			
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C415	BRIDGE B07-01 PLAN AND PROFILE - SHEET 3			
C416	BRIDGE B07-01 CROSS SECTIONS - SHEET 1			
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C422	BRIDGE B09-02 PLAN			
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C425	BRIDGE B10-01 CROSS SECTIONS - SHEET 1			
C426	BRIDGE B10-01 CROSS SECTIONS - SHEET 2			
C427	BRIDGE B10-02 PLAN AND PROFILE - SHEET 1			

LOCALITY PLAN

N.T.S.

Drawing No.	Drawing Title
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C429	BRIDGE B10-02 CROSS SECTIONS - SHEET 1
C430	BRIDGE B10-02 CROSS SECTIONS - SHEET 2
C431	BRIDGE B10-02 CROSS SECTIONS - SHEET 3
C432	BRIDGE B11-01 PLAN
C433	BRIDGE B13-01 PLAN AND PROFILE
C434	BRIDGE B13-01 CROSS SECTIONS - SHEET 1
C435	BRIDGE B13-01 CROSS SECTIONS - SHEET 2
C436	BRIDGE B14-01 PLAN AND PROFILE - SHEET 1
C437	BRIDGE B14-01 PLAN AND PROFILE - SHEET 2
C438	BRIDGE B14-01 PLAN AND PROFILE - SHEET 3
C439	BRIDGE B14-01 CROSS SECTIONS - SHEET 1
C440	BRIDGE B14-01 CROSS SECTIONS - SHEET 2
C441	BRIDGE B14-01 CROSS SECTIONS - SHEET 3
C442	BRIDGE B14-01 CROSS SECTIONS - SHEET 4
C443	BRIDGE B14-02 PLAN AND PROFILE
C444	BRIDGE B14-02 CROSS SECTIONS - SHEET 1
C445	BRIDGE B14-02 CROSS SECTIONS - SHEET 2
C446	BRIDGE B15-01, B15-02 PLAN
C447	BRIDGE B15-03, 04, 05 PLAN AND PROFILE OPTION 1 - SHEET 1
C448	BRIDGE B15-03, 04, 05 PLAN AND PROFILE OPTION 1 - SHEET 2
C449	BRIDGE B15-03, 04, 05 PLAN AND PROFILE OPTION 1 - SHEET 3
C450	BRIDGE B15-03, 04, 05 PLAN AND PROFILE OPTION 1 - SHEET 4
C451	BRIDGE B15-03, 04, 05 CROSS SECTION OPTION 1 - SHEET 1
C452	BRIDGE B15-03, 04, 05 CROSS SECTION OPTION 1 - SHEET 2
C453	BRIDGE B15-03, 04, 05 CROSS SECTION OPTION 1 - SHEET 3
C454	BRIDGE B15-03, 04, 05 CROSS SECTION OPTION 1 - SHEET 4
C455	BRIDGE B15-03, 04, 05 CROSS SECTION OPTION 1 - SHEET 5
C456	BRIDGE B15-03, B15-04, B15-05 PLAN OPTION 2

PREPARED FOR





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DATE: 19-07-202

BE220677 C000

PROJECT SPECIFICATIONS

- ALL DRAWINGS UNDER THIS CONTRACT ARE TO BE READ IN CONJUNTION WITH THE RELEVANT
- SPECIFICATIONS
 THE TECHNICAL SPECIFICATION PROVIDED AS PART OF THE CONTRACT DOCUMENTATION SHALL PREVAIL TO THE EXTENT OF ANY INCONSISTENCIES WITH OTHER SPECIFICATIONS, STANDARDS, AND GUIDLEINES REFERRED TO ON THE DRAWINGS.
- THE NORTHERN RIVERS LOCAL GOVERNMENT DEVELOPMENT DESIGN AND CONSTRUTION SPECIFICATIONS APPLY TO THIS PACKAGE OF WORK

DESIGN INTENT

DESIGN AND CONSTRUCTION TO MEET THE FOLLOWING PERFORMANCE REQUIREMENTS:

- FIT FOR PURPOSE DESIGN (LOW EMBELLISHMENT) AND CONSTRUCTION CONSIDERING BUDGETARY CONSTRAINTS ALLOWING MINOR ON-SITE ADAPTATION AS REQUIRED TO BETTER MEET LOCAL SITE CONDITIONS.
- EXTENT OF EXCAVATION SHALL BE MINIMISED WHEREVER POSSIBLE WHILST MINIMISING TRAIL LONGITUDINAL
- HEIGHT OF BATTER EXCAVATIONS SHALL BE ≤600mm UNLESS RETAINING STRUCTURE USED, UNLESS NOTED OTHERWISE (UNO) FOR RAIL FORMATION DEPARTURE RAMPS. STRUCTURAL DESIGN (BY OTHERS) REQUIRED FOR RETAINING STRUCTURES >600mm
- 1 IN 1.5 (V:H) (MAX) EXCAVATION BATTER. RETAINING STRUCTURE TO BE USED IF POOR SOIL CONDITIONS ARE ENCOUNTERED
- TRAIL WIDTH TO BE 3.0m WITH 250mm SHOULDERS (BOTH SIDES) WHEREVER POSSIBLE.
- MINIMUM TURNING RADIUS OF 2m FOR TURNS >90°. WHERE THIS CANNOT BE ACHIEVED, LOCALISE TRAIL WIDENING OR 3m (MIN) TURNING PLATFORM SHALL BE PROVIDED

GENERAL NOTES

- 1. ALL WORKS ARE TO COMPLY WITH THESE DRAWINGS UNLESS OTHERWISE AGREED WITH THE PRINCIPAL'S AUTHORISED PERSON
- ALL WORK SHALL BE CARRIED OUT IN COMPLIANCE WITH THE NEW SOUTH WALES WORK HEALTH AND CONSTRUCTION SAFETY ACT. REGULATIONS AND GUIDELINES.
- UNLESS SPECIFIED OTHERWISE, ALL MATERIALS AND WORK SHALL COMPLY WITH THE RELEVANT AUSTRALIAN STANDARDS AND STATUTORY REGULATIONS.
- SETOUT CO-ORDINATES/DIMENSIONS ARE TO BE CONFIRMED ON SITE BY THE CONSTRUCTION TEAM PRIOR TO COMMENCING WORK, DIMENSIONS SHALL NOT BE SCALED FROM THE DRAWINGS, WHERE DIMENSIONS CANNOT BE DETERMINED FROM THE DRAWINGS, CLARIFICATION SHALL BE SOUGHT FROM THE PRINCIPAL'S AUTHORISED PERSON PRIOR TO COMMENCING WORK.
- ANY DISCREPANCY SHALL BE REFERRED TO THE PRINCIPAL'S AUTHORISED PERSON BEFORE PROCEEDING WITH ANY WORK. NO SUBSTITUTE MATERIALS SHALL BE USED WITHOUT PRIOR APPROVAL OF THE PRINCIPAL'S
- THE CONSTRUCTION TEAM SHALL MAKE THEMSELVES FULLY CONVERSANT WITH ALL EXISTING STRUCTURES AND SERVICES WITHIN AND ADJACENT TO THE SITE OF THE WORK AND PLAN THE WORK ACCORDINGLY. ANY DAMAGE TO BE REPORTED TO THE PRINCIPAL'S AUTHORISED PERSON AS SOON AS THE CONTRACTOR BECOMES
- WHERE PROPRIETARY ITEMS ARE SPECIFIED ON THE DRAWINGS, ALTERNATIVES MAY BE USED IF APPROVED BY THE PRINCIPAL'S AUTHORISED PERSON, PROPRIETARY ITEMS SHALL BE INSTALLED IN ACCORDANCE WITH THE MANUFACTURERS' SPECIFICATIONS.
- WHERE EXISTING ACCESS TRACKS ARE AFFECTED BY THE WORKS, THE ACCESS TRACKS SHALL BE RE-ESTABLISHED, AS A MINIMUM, TO THE PRE-WORKS CONDITION TO THE SATISFACTION OF THE PRINCIPAL'S AUTHORISED PERSON.
- MODIFICATION TO TRAIL DETAILS AND ROUTE ALIGNMENT CAN BE UNDERTAKEN DURING CONSTRUCTION TO BETTER SUIT LOCAL SITE CONDITIONS UNDER THE DIRECTION OF THE PRINCIPAL'S AUTHORISED PERSON
- THE CONSTRUCTION TEAM SHALL NOT ENTER ADJACENT LANDHOLDER PROPERTIES UNLESS PRIOR APPROVAL HAS BEEN GRANTED
- TEMPORARY FENCING IS TO BE INSTALLED AS REQUIRED WHERE WORKS IMPACT ON EXISTING FENCES PRIOR TO REINSTATEMENT TO THE SATISFACTION OF THE PRINCIPAL'S AUTHORISED PERSON OR INSTALLATION OF PERMANENT REPLACEMENT INFRASTRUCTURE (GATES, ETC).
- 12. ACCESS TRAILS AND ASSOCIATED INFRASTRUCTURE MUST BE CONSTRUCTED TOTALLY WITHIN THE RAIL CORRIDOR UNLESS OTHERWISE NOTED
- RESTORE EXISTING ROADS, DRAINAGE WORKS AND OTHER INFRASTRUCTURE ITEMS TO THEIR ORIGINAL OR SPECIFIC CONDITIONS UPON COMPLETION OF THE WORKS.

SURVEY NOTES

- ALL DIMENSIONS ARE IN METRES, UNLESS NOTED OTHERWISE (UNO). ALL LEVELS IN AHD UNO.
- ALL SETOUT POINTS ARE PROVIDED IN THE MGA ZONE 56 COORDINATE SYSTEM

ENVIRONMENTAL MANAGEMENT AND APPROVALS NOTES

- THE CONTRACTOR IS TO CONFORM TO THE ENVIRONMENTAL REQUIREMENTS DESCRIBED IN THE CONTRACT DOCUMENTS. IN PARTICULAR THE REVIEW OF ENVIRONMENTAL FACTORS (REF)
- THE CONTRACTOR SHALL PREPARE AND IMPLEMENT A CONSTRUCTION ENVIRONMENTAL MANAGEMENT PLAN (CEMP) FOR ALL WORKS AS DESCRIBED IN THE REF. COPIES OF THE CEMP MUST BE PROVIDED TO THE PRINCIPAL'S AUTHORISED PERSON PRIOR TO CONSTRUCTION.
- BEFORE COMMENCING CONSTRUCTION WORK ALL NECESSARY ENVIRONMENTAL APPROVALS RELATING TO WORKS WITHIN WATERWAYS AND VEGETATION DISTURBANCE SHALL BE OBTAINED BY COUNCIL
- THE CONSTRUCTION TEAM SHALL ENSURE THAT THE WORKS ARE COMPLETED IN STRICT ACCORDANCE WITH THE CONDITIONS IN ANY ENVIRONMENTAL APPROVALS AND ANY FUTURE AMENDMENTS TO THESE APPROVALS:
- THE WORKS SHALL BE UNDERTAKEN IN ACCORDANCE WITH THE EROSION AND SEDIMENT CONTROL PLAN (ESC PLAN) DEVELOPED FOR THE WORKS. THE ESC PLAN DETAILS MANAGEMENT STRATEGIES FOR SEDIMENT CONTROL DURING CONSTRUCTION. THE ESC PLAN SHALL BE DEVELOPED IN ACCORDANCE WITH THE BEST PRACTICE EROSION AND SEDIMENT CONTROL DOCUMENT (IECA, 2008). THIS SHALL INCLUDE CONTROLS AND MANAGEMENT STRATEGIES FOR INSTREAM WORKS.
- THE DISTURBANCE AREAS ASSOCIATED WITH EACH CONSTRUCTION AREA SHALL BE CONFIRMED WITH COUNCIL PRIOR TO COMMENCING WORKS. ALL CONSTRUCTION ACTIVITIES INCLUDING LAYDOWN AREAS AND STOCKPILES MUST BE CONSTRUCTED WITHIN THE DISTURBANCE AREA.
- LAYDOWN AREAS AND STOCKPILES SHALL NOT BE LOCATED WITHIN THE BED AND BANKS OF THE
- NO AREAS OUTSIDE OF THE DESIGNATED WORK AREAS WILL BE DISTURBED WITHOUT PRIOR

EARTHWORKS NOTES

FW1 - CLEARING AND GRUBBING

1.1. CLEARING, STRIPPING AND GRUBBING SHALL BE CARRIED OUT IN AREAS SUBJECT TO EARTHWORKS TO A MINIMUM DEPTH OF 100mm OR AS OTHERWISE DETAILED ON THE DRAWINGS. ALL SOIL CONTAINING ORGANIC MATTER SHALL BE STRIPPED FROM THE WORKS AREA AND DISPOSED OF, STOCKPILED FOR FUTURE SITE REHABILITATION OR USED AS TOPSOIL.

FW2 - MATERIAL SPECIFICATION - SELECT FILL

- 2.1. ALL MATERIALS USED AS FILL SHALL BE FREE FROM DELETERIOUS MATTER.
- 2.2. TESTING OF MATERIAL TO BE UNDERTAKEN BY A NATA REGISTERED ORGANISATION.
- 2.3. NO MATERIAL CONTAINING THE FOLLOWING MAY BE USED:
- VEGETABLE MATTER
- RAILWAY CONTAMINATES INCLUDING DOG SPIKES, BARBED WIRE AND SIMILAR MATERIAL ORGANIC CLAYS OR SILTS
- ASHES, COAL OR THE LIKE
- DISPERSIVE SOIL.
- 2.4. IT IS ASSUMED THAT EARTH FILL SOURCED FROM THE EXISTING RAIL FORMATION SATISFIES THE REQUIREMENTS OF SELECT FILL

EW3 - PLACING AND COMPACTING OF SELECT FILL

- 3.1. THE SELECT FILL SHOULD BE PLACED IN UNIFORM LAYERS OVER THE FULL WIDTH OF THE EXCAVATIONS WITH THE LAYERS NOT EXCEEDING 150mm THICKNESS, LOOSELY PLACED.

 3.2. IF THE SURFACE OF ANY LAYER IS SMOOTH (OR AT THE BEGINNING OF A NEW DAYS WORK), IT
- SHALL BE SCARIFIED TO A DEPTH OF 30mm PRIOR TO PLACEMENT OF THE NEXT LAYER.
- 3.3. EACH LAYER OF FILL MATERIAL SHALL BE COMPACTED WITH APPROPRIATE EQUIPMENT GIVEN SITE
- 3.4. SELECT FILL SHALL BE COMPACTED TO NOT LESS THAN 95% OF STANDARD MAXIMUM DRY DENSITY (SMDD) AND ± 2% OF OPTIMUM MOISTURE CONTENT (OMC). TESTING SHALL BE UNDERTAKEN IN ACCORDANCE WITH COUNCIL'S STANDARD PROTOCOLS.

DUMPED ROCK NOTES

DR1 - DUMPED ROCK GRADING

1.1. THE RIP RAP SHALL BE WELL GRADED AND SHALL CONFORM WITH THE GRADING REQUIREMENTS SPECIFIED ON THE DRAWINGS

DR2 - QUALITY OF MATERIAL

- 2.1. ROCK SHALL BE CLEAN, HARD, DENSE AND DURABLE IGNEOUS OR METAMORPHIC
- 2.2. ROCK SHALL BE RESISTANT TO WEATHERING, FREE FROM OVERBURDEN, SPOIL, SHALE AND ORGANIC MATTER.
- 2.3. ROCK THAT IS LAMINATED, FRACTURED, POROUS, WITH DISCONTINUITIES OR OTHERWISE PHYSICALLY WEAK, SHALL NOT BE USED.
- 2.4. SEDIMENTARY ROCKS SHALL NOT BE USED.
- 2.5. THE BREADTH OR THICKNESS OF A SINGLE STONE SHALL BE NOT LESS THAN ONE-THIRD ITS LENGTH.

DR3 - METHOD OF PLACEMENT OF DUMPED ROCK

- 3.1. DUMPED ROCK SHALL BE PLACED IN SUCH A MANNER AS TO PRODUCE A WELL-GRADED MASS OF ROCK WITH THE MINIMUM PRACTICABLE PERCENTAGE OF VOIDS.
- 3.2. REARRANGING OF INDIVIDUAL STONES WILL BE REQUIRED TO THE EXTENT NECESSARY TO OBTAIN A WELL-GRADED DISTRIBUTION OF STONE SIZES AS SPECIFIED ABOVE. HOWEVER, MANIPULATING STONE BY MEANS OF DOZERS OR OTHER BLADE EQUIPMENT SHALL NOT BE PERMITTED.
- 3.3. THE FINAL SURFACE SHALL BE SMOOTH WITH NO VOIDS GREATER THAN 50mm PRESENT BETWEEN ROCKS
- 3.4. UNLESS SPECIFIED OTHERWISE ON THE DRAWINGS, ROCK SHALL BE PLACED TO A MINIMUM THICKNESS 2 TIMES THE MEDIAN DIAMETER (I.E. d50). 3.5. IN NO CASE IS ROCK TO BE DROPPED ONTO THE GEOTEXTILE. IF LARGE ROCK IS
- DROPPED ONTO THE GEOTEXTILE, THE GEOTEXTILE SHALL BE INSPECTED FOR DAMAGE AND REPAIRED TO THE SATISFACTION OF THE PRINCIPAL'S AUTHORISED PERSON.

GEOTEXTILE UNDERLAY NOTES

- GEOTEXTILE SHALL BE INSTALLED AT ALL ROCK AND PREPARED SOIL INTERFACES UNLESS BED LEVEL CROSSINGS ARE BEING CONSTRUCTED IN NATURAL COBBLED WATERWAYS UTILISING LOCALLY SOURCED MATERIAL
- GEOTEXTILE FABRIC SHALL BE NON-WOVEN, NEEDLE-PUNCHED PRODUCT CONSISTING OF STRONG, ROT-PROOF POLYMETRIC YARN OR FIBRES
- 3. LAPPING AND STAPLING OF THE GEOTEXTILE SHALL BE IN ACCORDANCE WITH THE MANUFACTURER 'S DIRECTIONS.

REVEGETATION NOTES

- TOPSOIL APPLICATION AND SEEDING SHALL BE UNDERTAKEN ON ALL DISTURBED SURFACES.
- TOPSOIL CONSISTS OF SURFACE SOIL AND VEGETABLE MATTER STRIPPED FROM EARTHWORKS AS SPECIFIED ON THE DRAWINGS FREE FROM:
 - ANY SUBSTANCES CONSIDERED DELETERIOUS TO PLANT
 - NOXIOUS WEED SPECIES
- TOPSOIL SHALL BE SPREAD ON ALL AREAS TO BE REVEGETATED TO A THICKNESS OF 50mm
- 4. SEEDING, FERTILISING AND WATERING SHALL BE UNDERTAKEN IN ACCORDANCE WITH COUNCIL SPECIFICATIONS

ISSUE FOR TENDER

NORTHERN RIVERS RAIL TRAIL **BENTLEY TO LISMORE**

LISMORE CITY COUNCIL



ISSUE FOR TENDER

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NORTHERN RIVERS **RAIL TRAIL - BENTLEY** TO LISMORE

DRAWING TITLE

GENERAL NOTES

DEVEL APPLIC No. DATE · 19-07-2023 ESIGNER: THUY VU DRAFTSPERSON: THUY VU CHECKED: TOBY BENNETT APPROVED FOR AND ON BEHALF OF BURCHILLS ENGINEERING SOLUTIONS ABN 76 166 942 365 AHD FULL SIZE : A1 SCALE : DATUM

C100

PROJECT N

BE220677

ORIGINAL SIZE BEFORE REDUCTION

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NOTE


RAIL TRAIL NOTES NOTES: RAILS TO BE STOCKPILED OR DISPOSED OF AS PER THE SPECIFICATIONS. PROVIDE SEPARATE BRIDLE TRAIL WITHIN CUTTINGS WHERE SLEEPERS TO BE RE-USED FOR LANDSCAPING OR DISPOSED OF AS PER THE SPACE PERMITS OTHERWISE MAXIMISE WIDTH TO ALLOW FOR SHARED USE PEDESTRIAN, CYCLE, AND HORSE TRAIL FACE OF EXISTING CUTTING. LOCALISED BARRIER FENCES TO BE INSTALLED WHERE REQUIRED IN ACCORDANCE WITH STABILISATION WORKS MAY BE REQUIRED FIGURE 5.10 AUSTROADS GUIDE TO ROAD DESIGN PART 6A. SUBJECT TO DETAILED GEOTECHNICAL ADVICE REFER TO ON-FORMATION PAVEMENT DETAILS ON C102 SCHEDULE OF TYPICAL CROSS SECTION LOCATIONS 3.50m FORMATION WIDTH 3.00m PATH WIDTH TOTAL LENGTH DESCRIPTION APPLICABLE CHAINAGES (APPROX..) SECTION (APPROX.) CROSSFALL 2.50% CHO-CH4370, CH4520-CH4720, CH4870- CH5570, CH5670-CH6170, CH6420-CH7370, CH7870-CH8870, CH8970-CH15370, 1 RAIL TRAIL ON EXISTING RAILWAY EMBANKMENT 13175m CH4720-CH4870, CH5570-CH5670, CH7510 RAIL TRAIL THROUGH EXISTING CUTTING (ONE SIDE) 250m CH4370-CH4520. CH6170-CH6420. CH7370-CH7510-CH7870. CH8870-CH8970 RAIL TRAIL THROUGH EXISTING CUTTING (BOTH SIDES) 1000m CH210-CH310, CH3680-CH3790, CH6970- CH7390, CH9930-CH10180, CH10640- CH10880, CH13680-CH13790, CH13890 -RAIL TRAIL ON NATURAL GROUND (OFF RAIL 4 2320m FORMATION) CH14220, CH14780-CH14910, CH15350- CH15980 MIN. 300mm DEEP TABLE DRAIN (RIP-RAP EXISTING RAILWAY SUBGRADE TO BE RE-PROFILED -ON NON-WOVEN GEOTEXTILE) TYPICAL CH190-CH210, CH310-CH330, CH3660-CH3680, CH3790-CH3810, CH7150-CH6970, CH7390-CH7410, CH9910-CH9930, TO ACHIEVE ONE WAY CROSSFALL GRADING TO EITHER SIDE TO SUIT LOCAL CONDITIONS RAIL TRAIL TRANSITION ON/OFF RAILWAY FORMATION CH10180 - CH10200 CH10620 - CH10640 CH10890 - CH10900 CH13660 - CH13680 CH13790 - CH13810 CH13870 -360m **TYPICAL SECTION 3** PROPOSED RAIL TRAIL THROUGH EXISTING CUTTING ON BOTH SIDES 1.00m WIDE REFER TO OFF-FORMATION PAVEMENT DETAILS ON C102 SI A SHED MIN. 300mm DEEP TABLE DRAIN -BRIDLE TRAIL (CONCRETE, TURF, OR RIP-RAP ON - FACE OF EXISTING CUTTING LOCALISED SHOULDER STABILISATION WORKS MAY BE REQUIRED NON-WOVEN GEOTEXTILE) TYPICAL SUBJECT TO DETAILED GEOTECHNICAL ADVICE REFER TO ON-FORMATION 3.50m FORMATION WIDTH EXTERNAL CATCHMENT CROSSEALL 2,50% CROSSFALL 2.50% NATURAL GROUND **TYPICAL SECTION 5** STABILISATION ONLY REQUIRED WHERE PROPOSED RAIL TRAIL ON NATURAL GROUND EXISTING GROUND CONDITIONS ARE MIN. 300mm DEEP TABLE DRAIN — (RIP-RAP ON NON-WOVEN UNSUITABLE. REFER DETAIL ON C102. EXISTING RAILWAY SUBGRADE TO BE GEOTEXTILE) TYPICAL RE-PROFILED TO ACHIEVE ONE WAY - STABILISATION ONLY REQUIRED WHERE CROSSEALL GRADING TO TABLE DRAIN SIDE EXISTING GROUND CONDITIONS ARE UNSUITABLE, REFER DETAIL ON C102. **TYPICAL SECTION 2** PROPOSED RAIL TRAIL THROUGH EXISTING CUTTING ON ONE SIDE PROFILE OF EXISTING RAIL EMBANKMENT 1.5 MAX. REFER TO ON-FORMATION SLASHED 3.50m FORMATION WIDTH BRIDLE TRAIL REFER TO OFF FORMATION 0.3-0.6m PAVEMENT DETAILS ON C102 RE-VEGETATED CUT BATTER CROSSFALL 2.50% CROSSFALL 2.5% 2 MAX. BY-PASS RAMP TABLE DRAIN (RIP-RAP ON GEOTEXTILE) EXISTING RAILWAY EMBANKMENT **TYPICAL SECTION 1 TYPICAL SECTION 4** STABILISATION ONLY REQUIRED WHERE PROPOSED RAIL TRAIL ON EXISTING RAILWAY FORMATION TRANSITION ON/OFF EXISTING RAILWAY FORMATION EXISTING GROUND CONDITIONS ARE ISSUE FOR TENDER DATE: 19-07-2023 COPYRIGHT (C) DRAWING TITLE : DEVEL APPLIC No. **BURCHILLS** NORTHERN RIVERS RAIL TRAIL DESIGNER: THUY VU DRAFTSPERSON: THUY VU CHECKED: TOBY BENNETT BENTLEY TO LISMORE DISCLAIMER DISCLAIMER This drawing and its contents are electronically generated, are confidential and may only be used for the purpose for which they were intended. Burchills Engineering Solutions will not accept responsibility for any consequences arising from the use of the drawing for other than its many content of the purpose or where the drawing has been attended, amended a dranged either manually or electronically by any third party. **NORTHERN RIVERS** Gold Coast I Brisbane I Toowoomba Ipswich I Moreton Bay Phone: +61 7 5509 6400 Fax: +61 7 5509 6411 **TYPICAL CROSS RAIL TRAIL - BENTLEY** LISMORE CITY COUNCIL **SECTIONS** TO LISMORE SCALE : DATUM: AHD FULL SIZE : A1 NOTE lismore Email: admin@burchills.com.au This is an uncontrolled document issued for information purposes only, unless the checked sections are signed or completed. Figured dimensions take precedence over scale. Do not scale reduced size drawings. Verify dimensions prior to commencing any on-site or Coote Burchills Engineering Pty Ltd PROJECT No ORIGINAL SIZE BEFORE REDUCTION A ISSUE FOR TENDER ABN 76 166 942 365 BE220677 C101

GEOTEXTILE (MEDIUM GRADE)

100mm THICK 25MPA WITH SL82 MESH CENTRALLY PLACED

100mm THICK COMPACTED CRUSHED GRAVEL (AS PER SPECIFICATION)

EXISTING RAILWAY BALLAST, REGRADE & COMPACT AFTER REMOVAL OF RAILS & SLFFPFRS

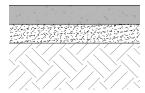

100mm THICK 25MPA WITH SL82 MESH CENTRALLY PLACED 100mm THICK COMPACTED CRUSHED GRAVEL (AS PER SPECIFICATION)

COMPACTED SUBGRADE AS PER SPECIFICATION

- GEOTEXTILE (MEDIUM GRADE) REPLACED NATURAL TOPSOIL MATERIAL (WHERE AVAILABLE) NATURAL SUBGRADE

SINGLE LAYER OF D50 = 100mm ROCK

ON-FORMATION SECTON

CONCRETE PAVEMENT DETAIL

0.1 0 0.1 0.2 0.3 0.4 0.5 (metres)

OFF-FORMATION SECTON

STABILISED BRIDLE TRAIL

0.1 0 0.1 0.2 0.3 0.4 0.5 (metres)

NOTES:

NOTE: ONLY REQUIRED WHERE NATURAL GROUND IS UNSUITABLE

- 25mm AC SEAL ON A 7mm PRIMERSEAL — GEOTEXTILE (MEDIUM GRADE) 125mm THICK COMPACTED CRUSHED GRAVEL (AS PER SPECIFICATION) EXISTING RAILWAY BALLAST. REGRADE & COMPACT AFTER REMOVAL OF RAILS & SLEEPERS

ON-FORMATION SECTON

SCALE 0.1 0 0.1 0.2 0.3 0.4 0.5 (metres)

- 25mm AC SEAL ON A 7mm PRIMERSEAL 150mm THICK COMPACTED CRUSHED GRAVEL (AS PER SPECIFICATION) COMPACTED SUBGRADE AS PER SPECIFICATION

OFF-FORMATION SECTON

SEALED PAVEMENT SECTIONS

GEOTEXTILE (MEDIUM GRADE)

100mm MIN THICK COMPACTED CRUSHED GRAVEL (AS PER SPECIFICATION)

EXISTING RAILWAY BALLAST. REGRADE & COMPACT AFTER REMOVAL OF RAILS

ON-FORMATION SECTON

150mm THK COMPACTED CRUSHED GRAVEL (AS PER SPECIFICATION)

COMPACTED SUBGRADE AS PER SPECIFICATION

OFF-FORMATION SECTON

UNSEALED PAVEMENT SECTIONS

NORTHERN RIVERS RAIL TRAIL BENTLEY TO LISMORE FOR LISMORE CITY COUNCIL

lismore

A ISSUE FOR TENDER

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Coote Burchills Engineering Pty Ltd ABN 76 166 942 365

RAIL TRAIL - BENTLEY TO LISMORE

DRAWING TITLE :

TYPICAL PAVEMENT **DETAILS**

DRAFTSPERSON: THUY VU

DEVEL APPLIC No.

RPEQ No.: 8093 SCALE : DATUM: AHD FULL SIZE : A1 PROJECT No. VERSION BE220677 C102

ISSUE FOR TENDER

DESIGNER: THUY VU


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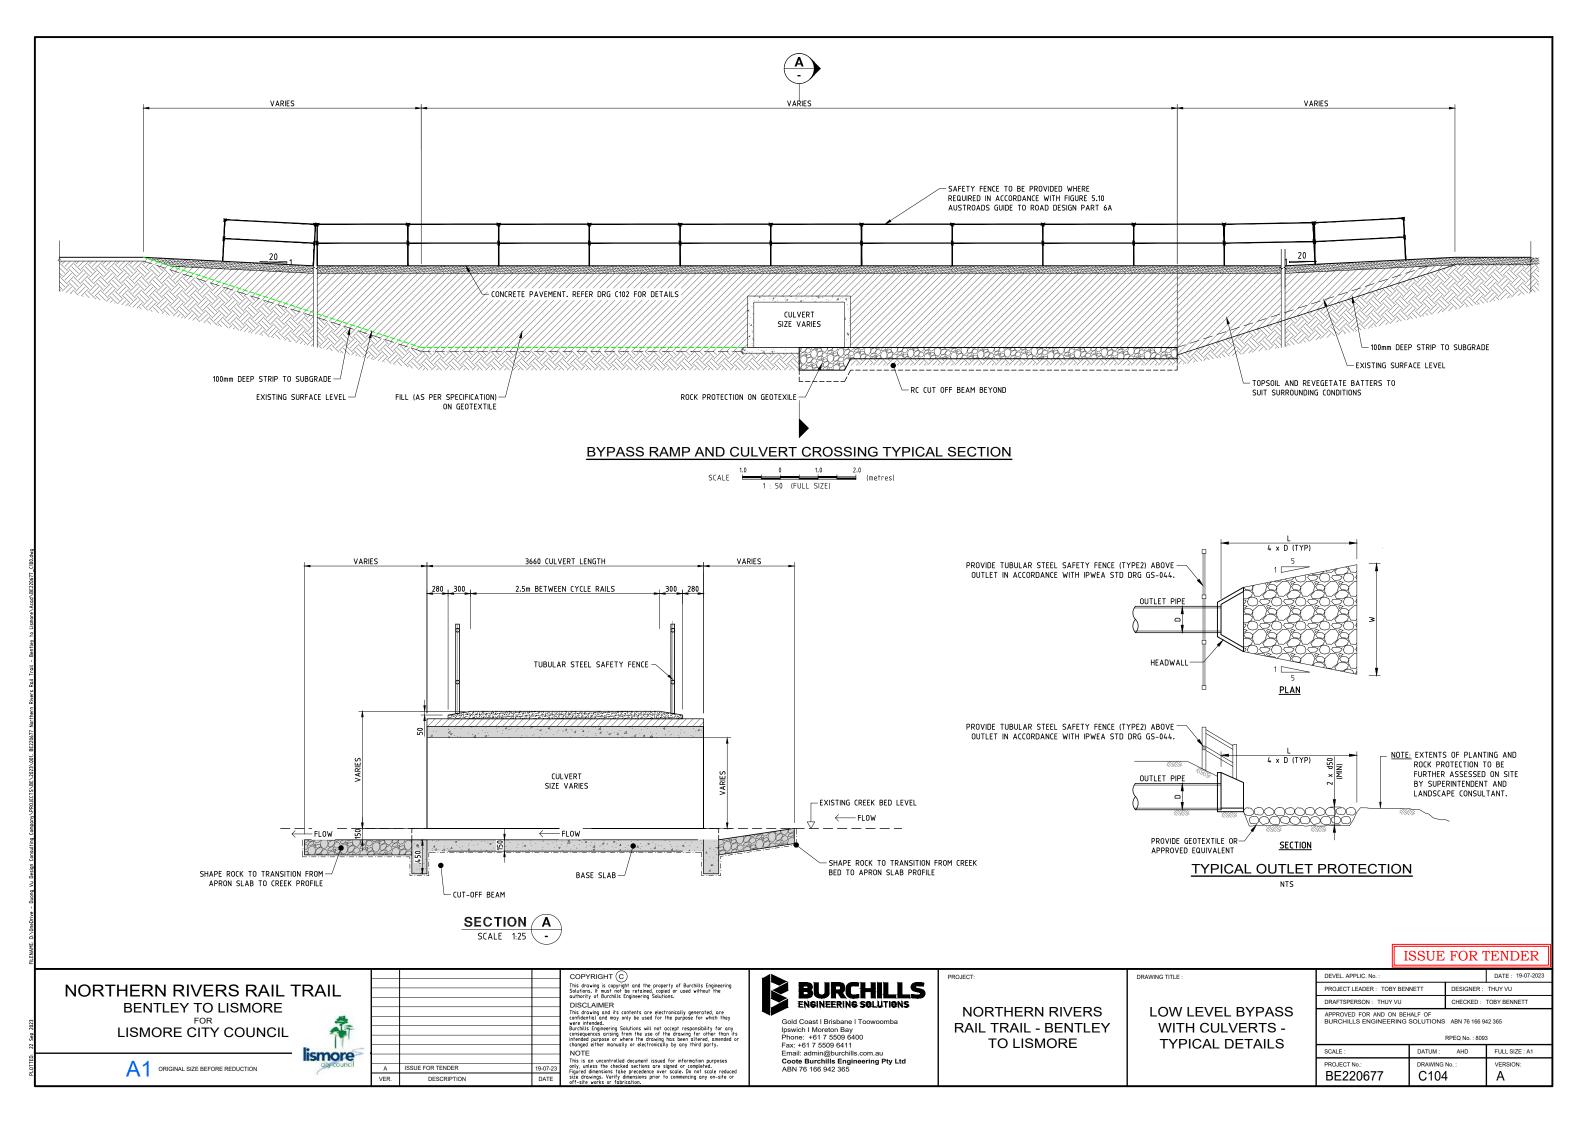
DATE: 19-07-2023


ORIGINAL SIZE BEFORE REDUCTION

BURCHILLS ENGINEERING SOLUTIONS

NORTHERN RIVERS



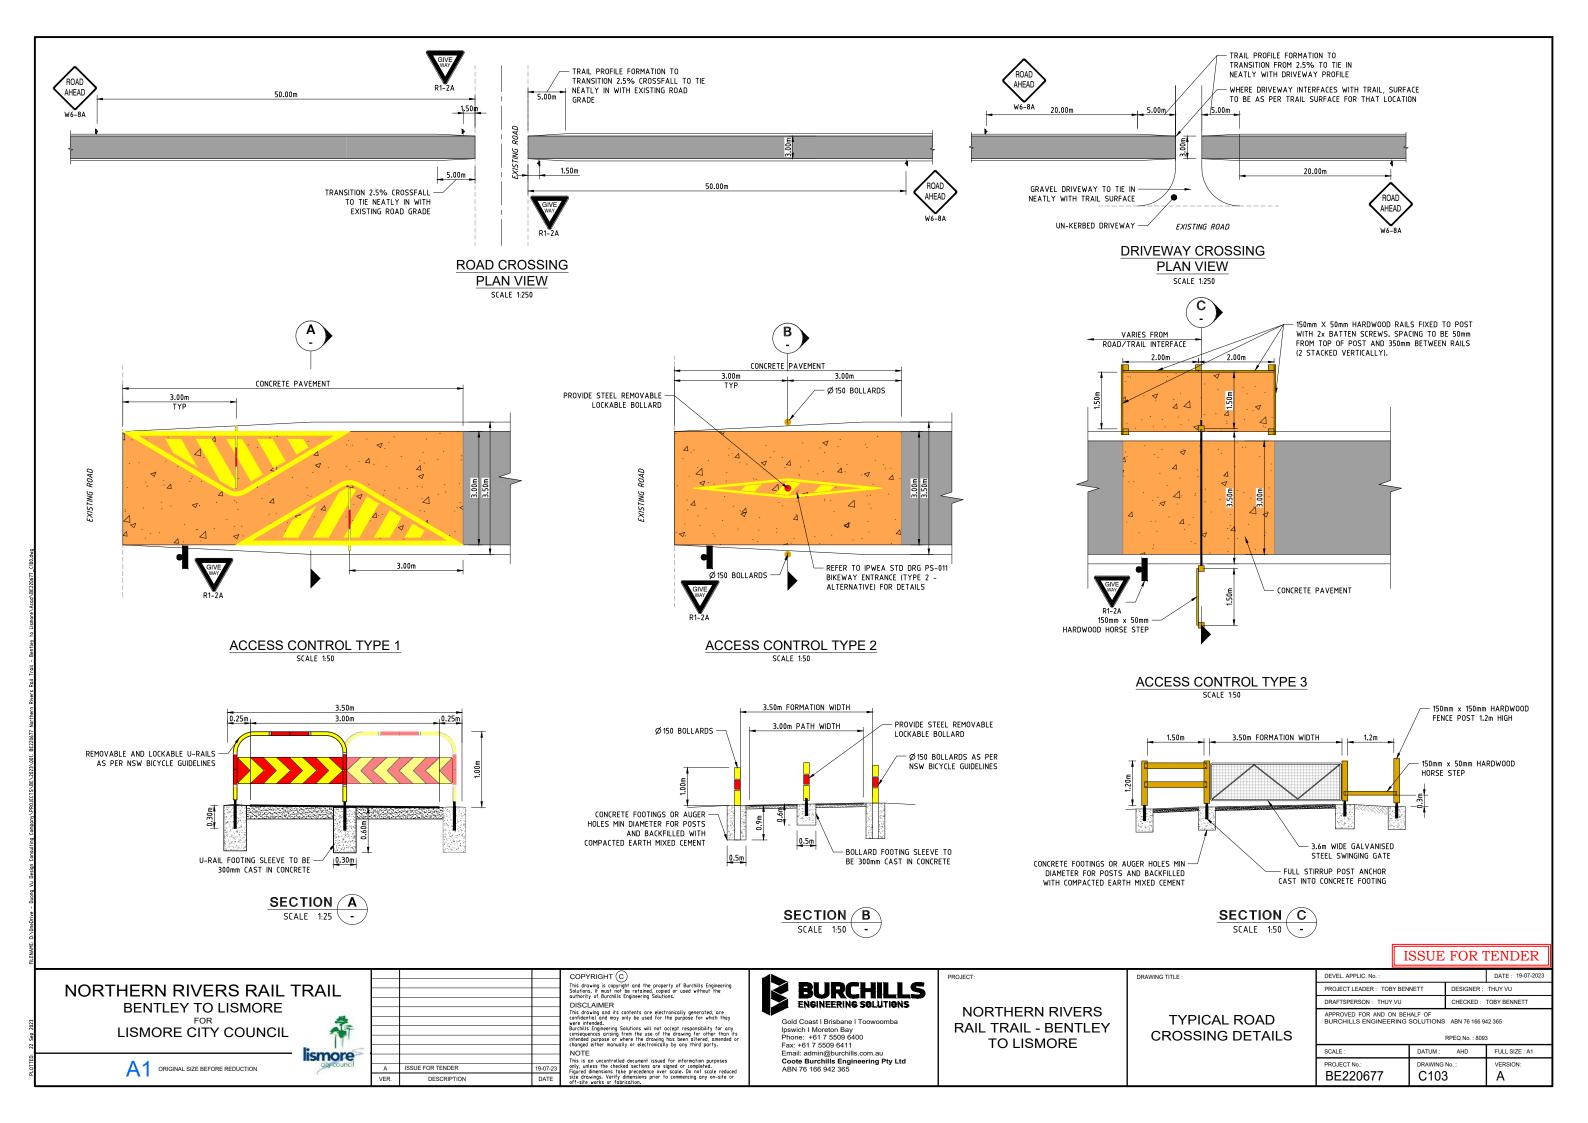

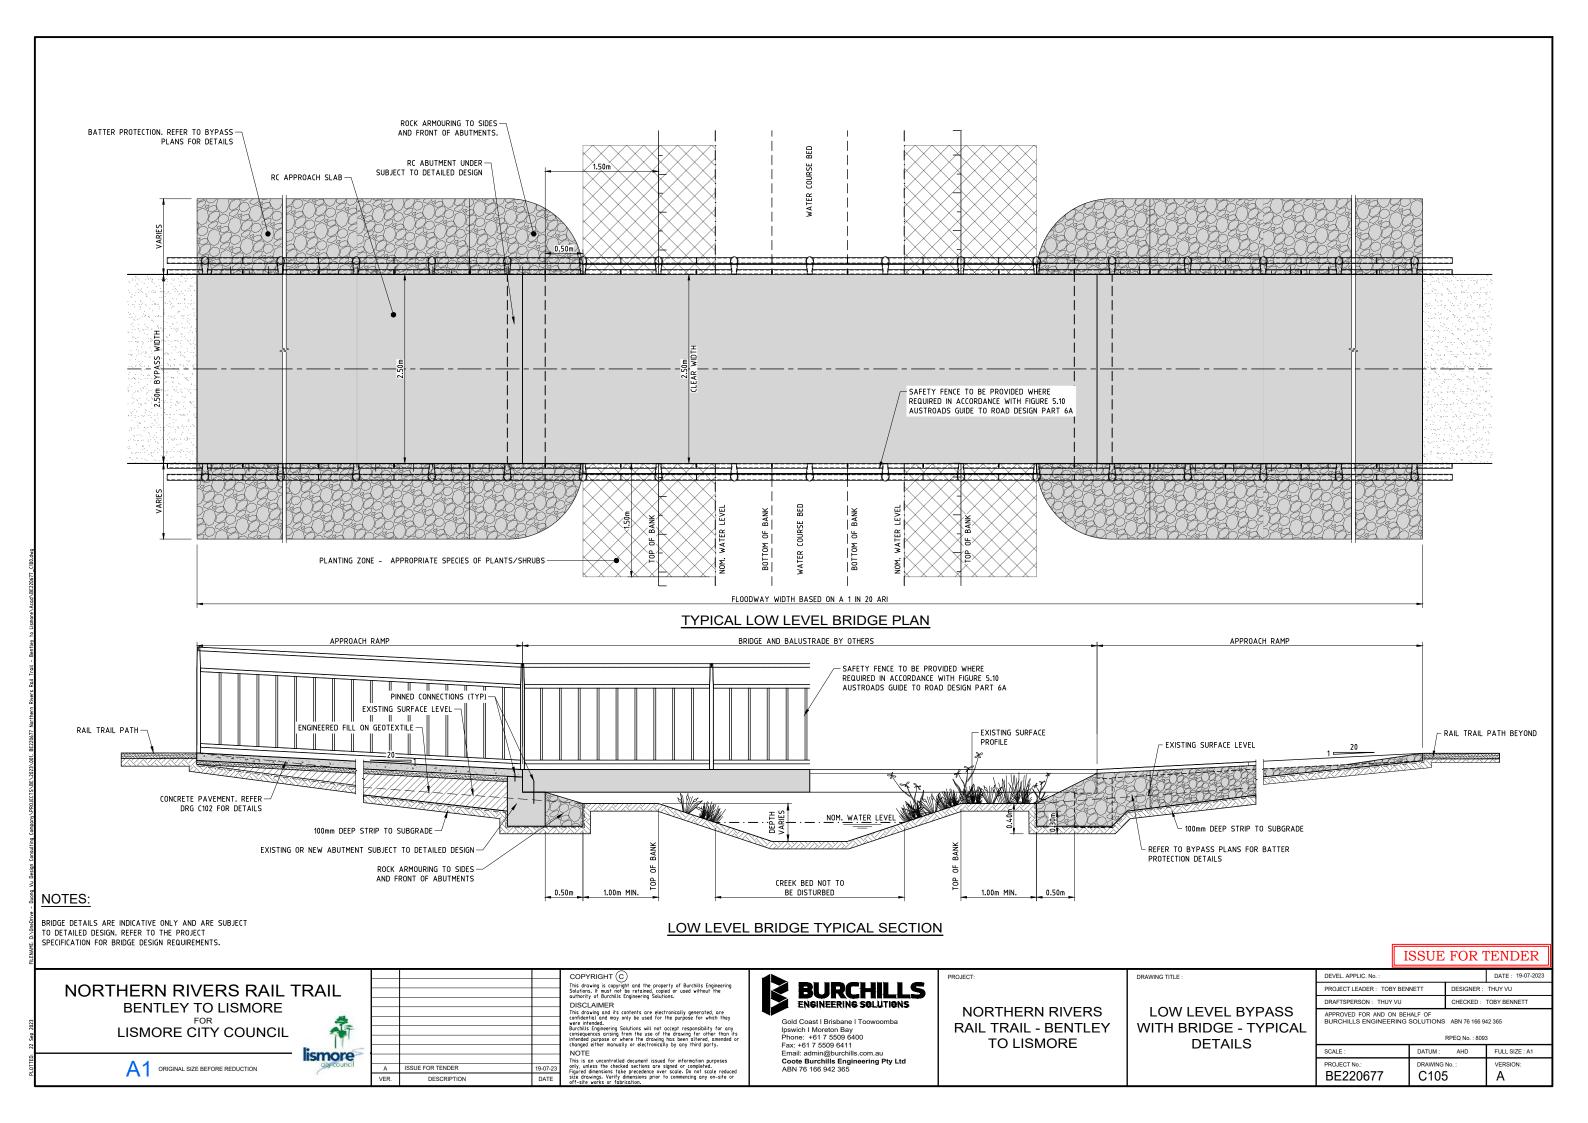


PRECAST CONCRETE DECK TYPICAL DETAILS

NOTES:

BRIDGE DETAILS ARE INDICATIVE ONLY AND ARE SUBJECT TO DETAILED DESIGN. REFER TO THE PROJECT SPECIFICATION FOR BRIDGE DESIGN REQUIREMENTS.



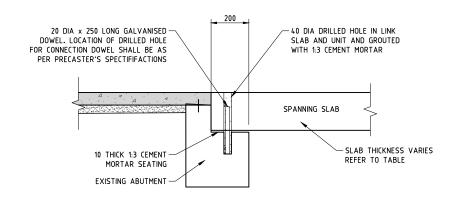

CONNECTION DETAILS

SCALE	0.1	0	0.1	0.2	0.3	0.4	0.5	(metres)
JCALL	_	1	: 10	(FULL	SIZE)	_	(illettes)

SLAB WIDTH	THICKNESS
(m)	(mm)
<1.6	185
1.6 TO 2.5	200
2.5 TO 2.8	240
2.8 TO 3.4	260
3.4 TO 4.0	300

NORTHERN RIVERS RAIL TRAIL BENTLEY TO LISMORE LISMORE CITY COUNCIL

COUNCIL ISMORE

A ISSUE FOR TENDER 19-0
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NORTHERN RIVERS RAIL TRAIL - BENTLEY TO LISMORE DRAWING TITLE :

LOW LEVEL DECK TYPICAL DETAILS

ISSUE FOR T	[EN]	DER
		40.07.00

PROJECT LEADER: TOBY BENNETT DESIGNER: THUY VU

DRAFTSPERSON: THUY VU


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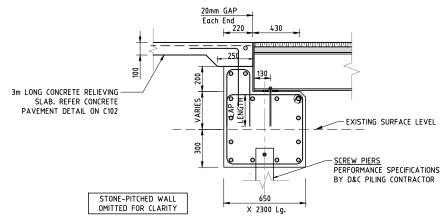
APPROVED FOR AND ON BEHALF OF
BURCHILLS ENGINEERING SOLUTIONS ABN 76 166 942 365

DEVEL. APPLIC. No.

RPEQ No.: 8093				
SCALE :	DATUM: AHD	FULL SIZE : A1		
PROJECT No.: BE220677	DRAWING No.: C106	VERSION:		

BRIDGE DETAILS ARE INDICATIVE ONLY AND ARE SUBJECT TO DETAILED DESIGN. REFER TO THE PROJECT SPECIFICATION FOR BRIDGE DESIGN REQUIREMENTS.



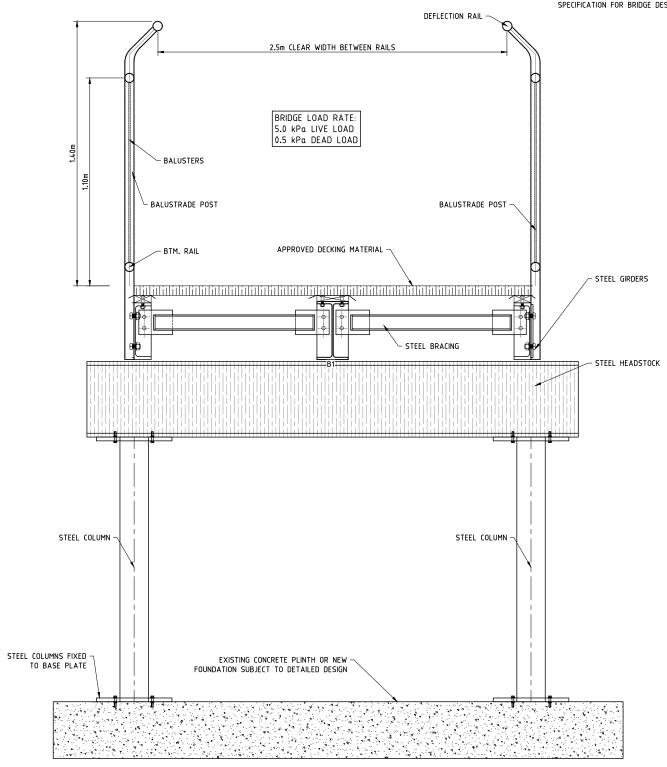


ABUTMENT TYPICAL SECTION

SCALE 0.1 0 0.1 0.2 (metres

TYPICAL CROSS SECTION STEEL BRIDGE REPLACEMENT OF EXISTING TIMBER RAIL BRIDGE

NORTHERN RIVERS RAIL TRAIL
BENTLEY TO LISMORE
LISMORE CITY COUNCIL

A1 ORIGINAL SIZE BEFORE REDUCTION

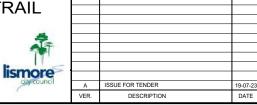

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PROJECT

NORTHERN RIVERS RAIL TRAIL - BENTLEY TO LISMORE DRAWING TITLE :


BRIDGE CROSSING DETAILS


ISSUE FOR TENDER DATE: 19-07-2023 TOBY BENNETT DESIGNER: THUY VU


CHECKED: TOBY BENNETT

DRAFTSPERSON: THUY VU CHI
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DEVEL APPLIC No.




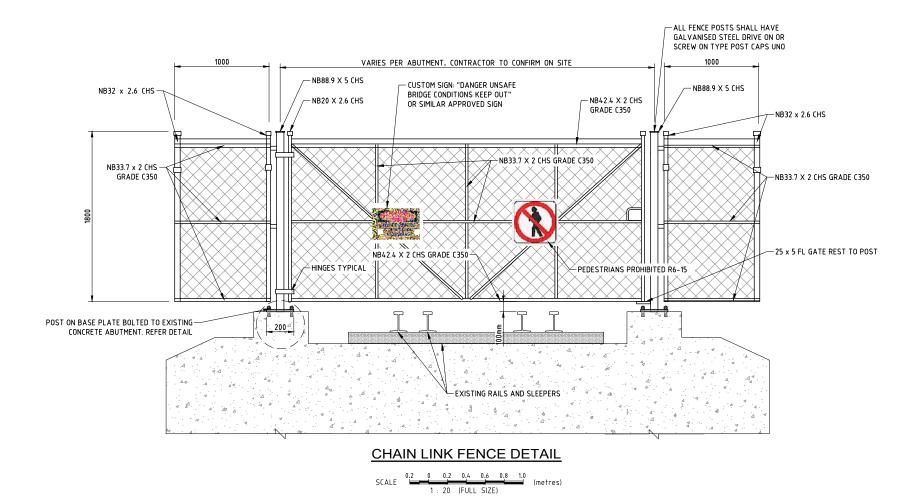

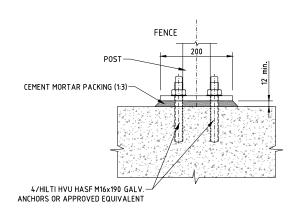

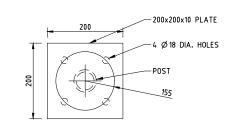POST ON BASE PLATE



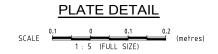

NORTHERN RIVERS RAIL TRAIL BENTLEY TO LISMORE LISMORE CITY COUNCIL

lismore A 1 ORIGINAL SIZE BEFORE REDUCTION

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ABN 76 166 942 365

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NORTHERN RIVERS **RAIL TRAIL - BENTLEY** CHAI

DRAWING TITLE :

	DEVEL. APPLIC. No. :		DATE: 19-07-2
	PROJECT LEADER: TOBY BENNETT	DESIGNER:	THUY VU
	DRAFTSPERSON: THUY VU	CHECKED :	TOBY BENNETT
IN LINK FENCE DETAIL	APPROVED FOR AND ON BEHALF OF BURCHILLS ENGINEERING SOLUTIONS ABN 76 166 942 365 RPEQ No. : 8093		


FULL SIZE : A1 PROJECT No.: VERSION: BE220677 C108

ISSUE FOR TENDER

DATE: 19-07-2023


Email: admin@burchills.com.au

Coote Burchills Engineering Pty Ltd

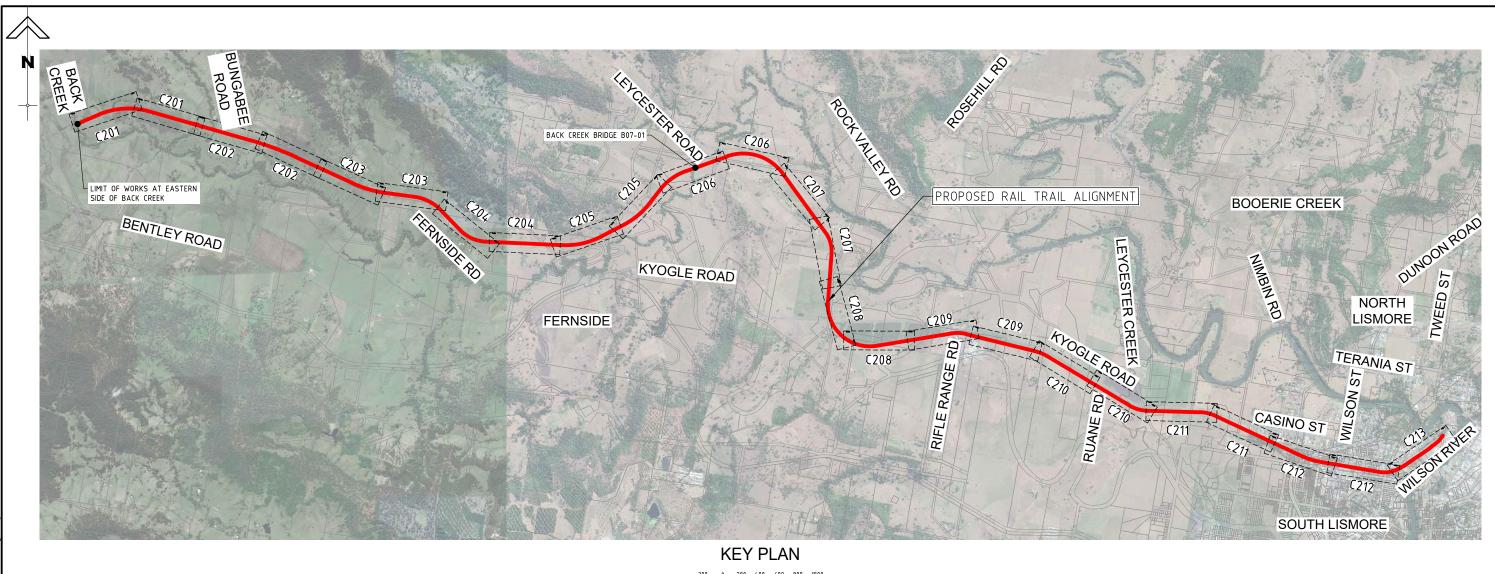

0 200 400 600 800 1000 (metres) 1 : 20000 (FULL SIZE)

LEGEND

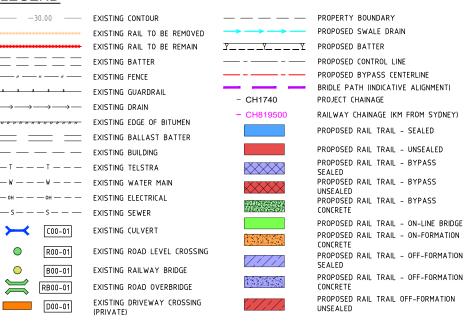

PROPOSED STOCK FENCE WITH STOCK GATE PROPOSED 2.4m HIGH SCREENING FENCE

PROPOSED CATTLE GRIDS

PROPOSED VEGETATION SCREENING

NORTHERN RIVERS RAIL TRAIL BENTLEY TO LISMORE LISMORE CITY COUNCIL

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NORTHERN RIVERS


DRAWING TITLE :

DEVEL APPLIC No. PROJECT LEADER: TOBY BENNET DRAFTSPERSON: THUY VU CHECKED: TOBY BENNETT RAIL TRAIL ALIGNMENT **KEY PLAN**


AHD FULL SIZE : A1 PROJECT No BE220677 C200

ISSUE FOR TENDER


ORIGINAL SIZE BEFORE REDUCTION

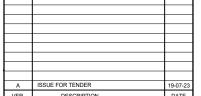

RAIL TRAIL - BENTLEY TO LISMORE

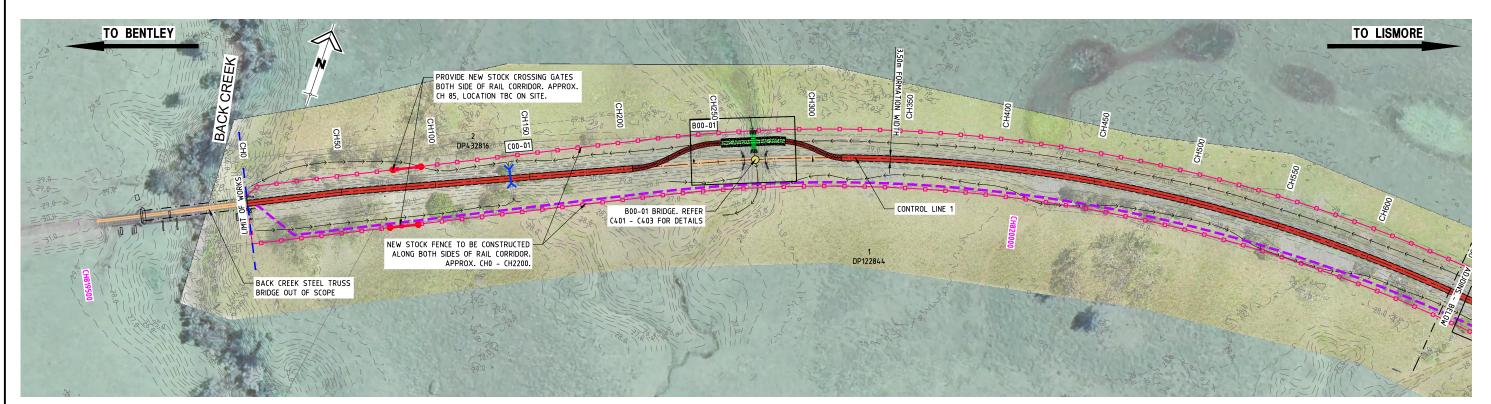



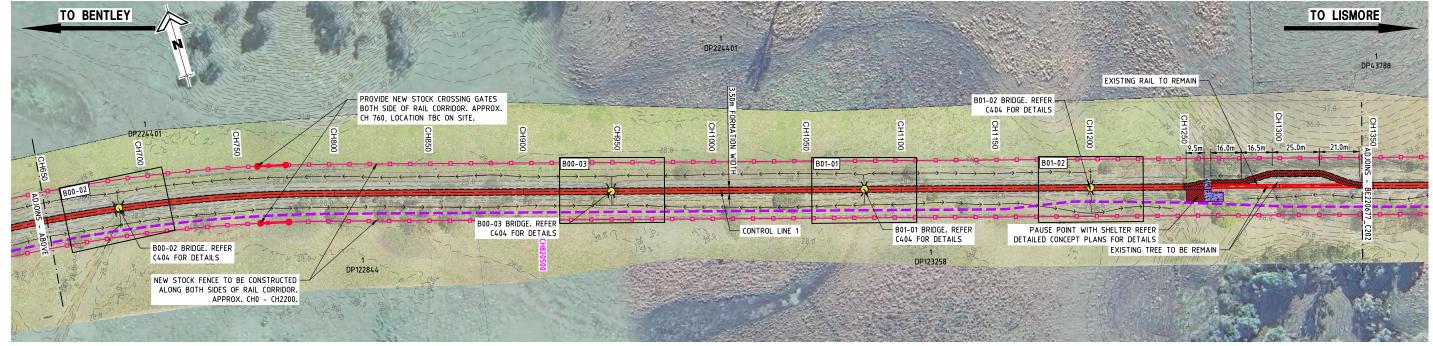

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SCALE 10 0 10 20 30 40 50 (metres)

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NORTHERN RIVERS RAIL TRAIL
BENTLEY TO LISMORE
LISMORE CITY COUNCIL

BENTLEY TO LISMORE
FOR
ISMORE CITY COUNCIL

A1 ORIGINAL SIZE BEFORE REDUCTION

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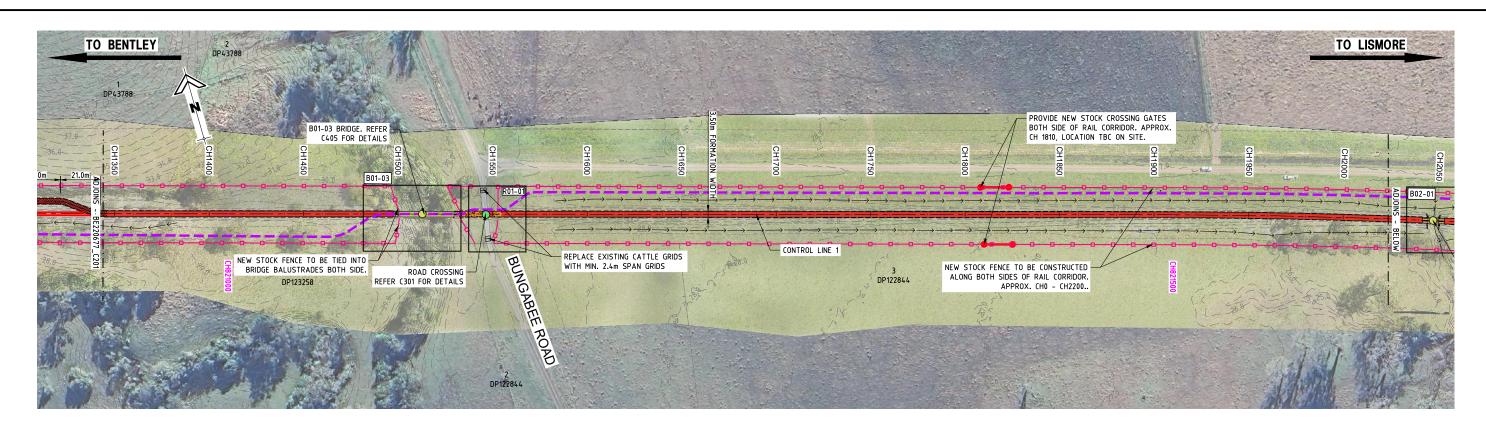
Gold Coast I Brisbane I Toowoomba Ipswich I Moreton Bay Phone: +61 7 5509 6400 Fax: +61 7 5509 6411 Email: admin@burchills.com.au Coote Burchills Engineering Pty Ltd ABN 76 166 942 365 NORTHERN RIVERS RAIL TRAIL - BENTLEY TO LISMORE

PLAN - SHEET 1


DRAWING TITLE :

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DEVEL. APPLIC. No. :	DATE: 19-07-2023		
PROJECT LEADER: TOBY BEN	NETT	DESIGNER:	THUY VU
DRAFTSPERSON: THUY VU		CHECKED:	TOBY BENNETT
APPROVED FOR AND ON BEI BURCHILLS ENGINEERING	ABN 76 166 94	42 365	
	RPEQ No.: 8093	3	
SCALE :	DATUM:	AHD	FULL SIZE : A1

PROJECT No.: DRAWING No.: VERSION:
BE220677 C201 A





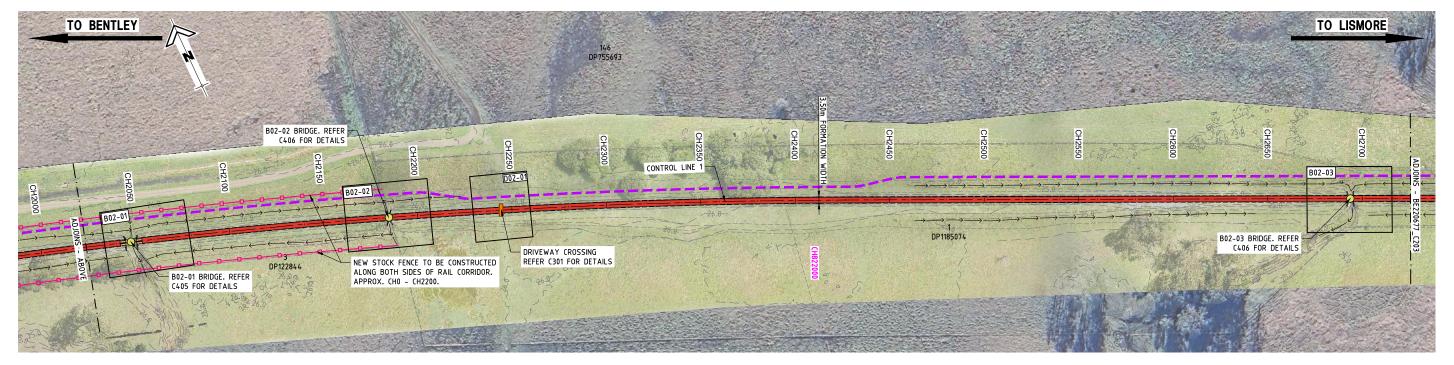

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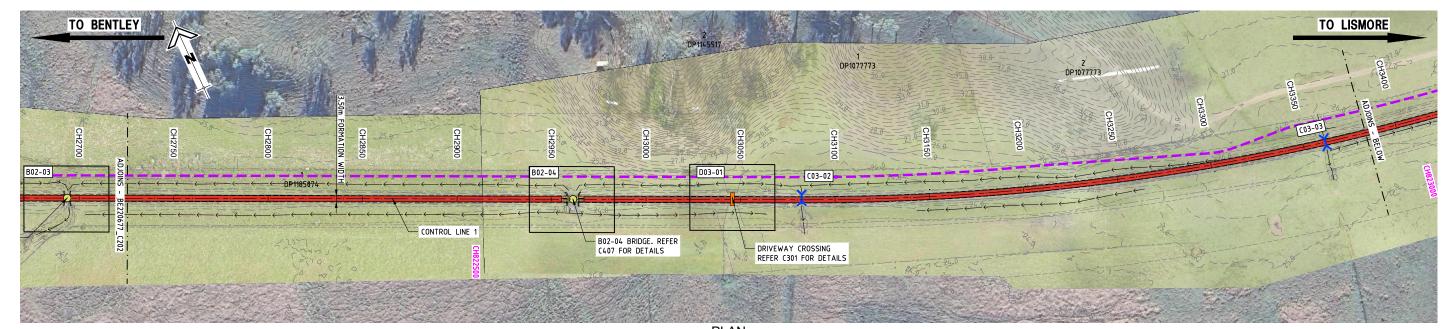
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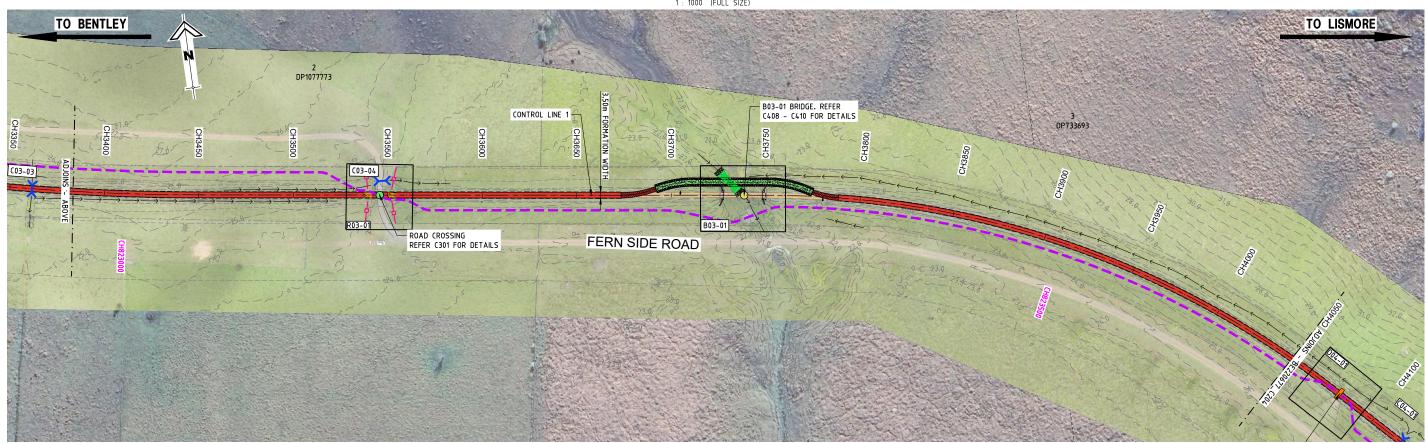
NORTHERN RIVERS RAIL TRAIL - BENTLEY TO LISMORE

PLAN - SHEET 2

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DEVEL. APPLIC. No. :			DATE: 19-07-2023	
PROJECT LEADER: TOBY BENNETT			DESIGNER: THUY VU	
DRAFTSPERSON: THUY VU	CHECKED:	TOBY BENNETT		
APPROVED FOR AND ON BEHALF OF BURCHILLS ENGINEERING SOLUTIONS ABN 76 166 942 365				
		RPEQ No.: 8093	3	
SCALE:	DATUM:	AHD	FULL SIZE : A1	
PROJECT No.: BE220677	C202		VERSION:	



PLAN 10 20 30 40 50 1 : 1000 (FULL SIZE)



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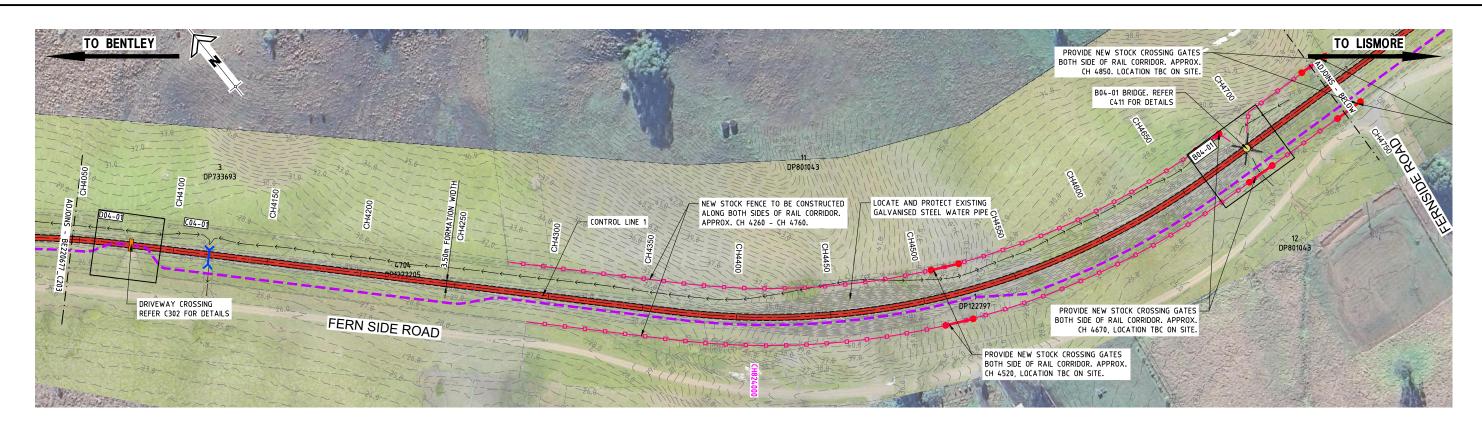
ABN 76 166 942 365 NORTHERN RIVERS RAIL TRAIL - BENTLEY TO LISMORE

PLAN - SHEET 3


DRAWING TITLE :

DEVEL. APPLIC. No. :		DATE: 19-07-2023
PROJECT LEADER: TOBY BENNETT	DESIGNER:	THUY VU
DRAFTSPERSON: THUY VU	CHECKED:	TOBY BENNETT
APPROVED FOR AND ON BEHALF OF BURCHILLS ENGINEERING SOLUTIONS	ABN 76 166 94	42 365

RPEQ No. : 8093					
SCALE :	DATUM: AHD	FULL SIZE : A1			
PROJECT No.: BE220677	C203	VERSION:			





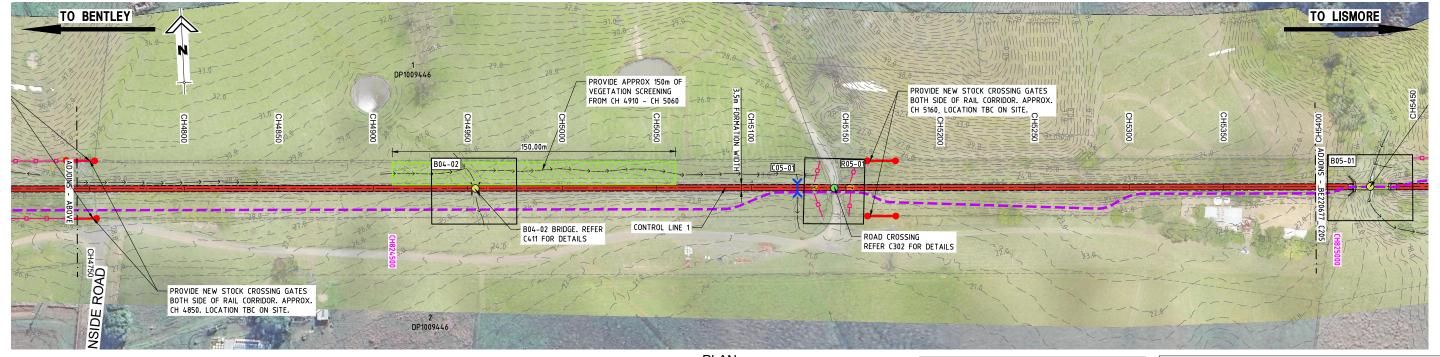

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PROJECT No.

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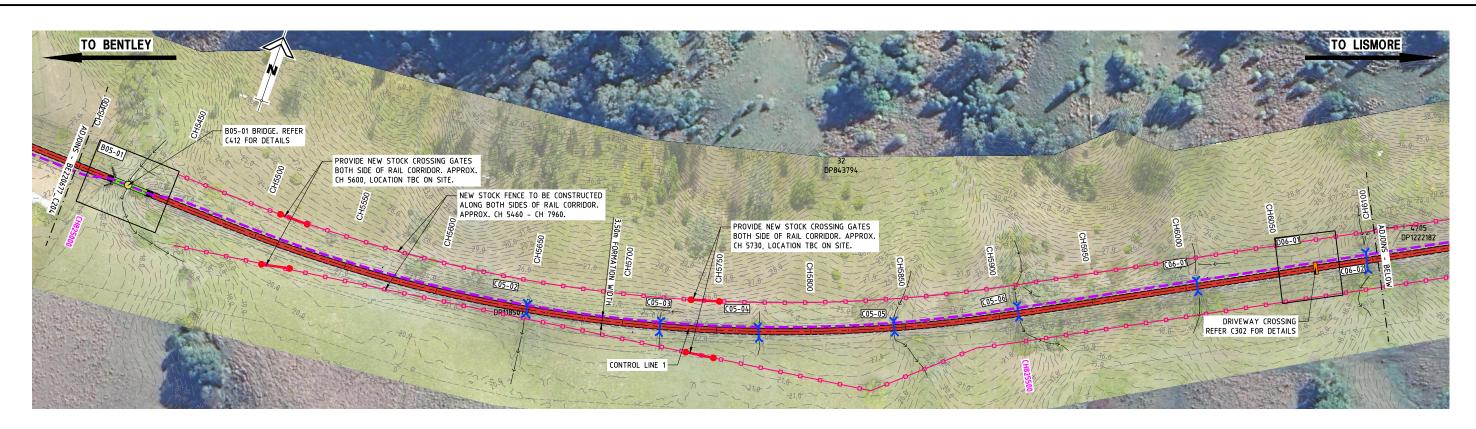
NORTHERN RIVERS RAIL TRAIL - BENTLEY TO LISMORE

PLAN - SHEET 4


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	DEVEL. APPLIC. No. :		DATE: 19-07-2023	
	PROJECT LEADER: TOBY BENNETT		DESIGNER: THUY VU	
	DRAFTSPERSON: THUY VU		CHECKED: TOBY BENNETT	
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NORTHERN RIVERS RAIL TRAIL BENTLEY TO LISMORE LISMORE CITY COUNCIL

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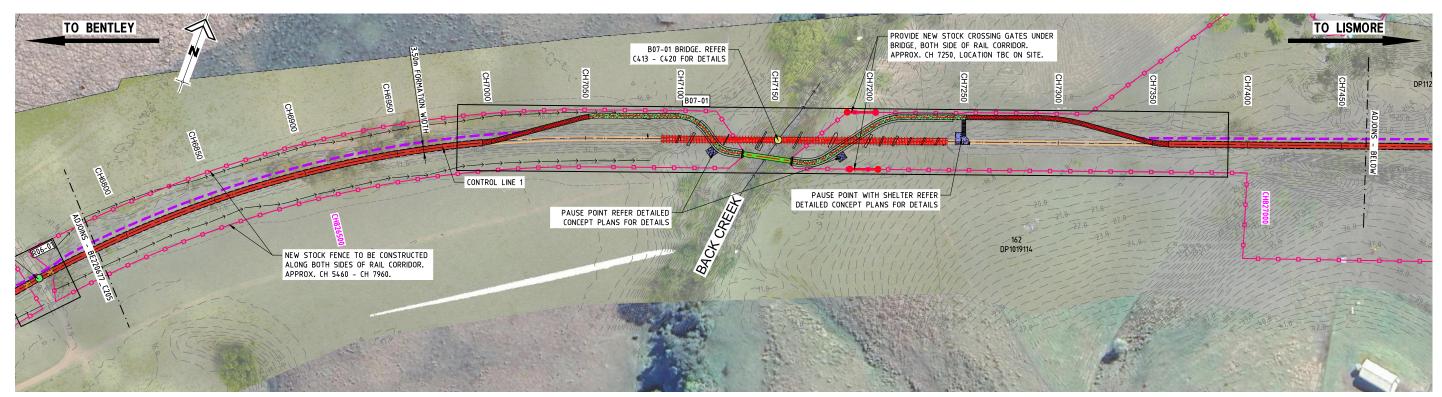
NORTHERN RIVERS RAIL TRAIL - BENTLEY TO LISMORE

PLAN - SHEET 5

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	DEVEL. APPLIC. No. :			DATE: 19-07-2023
	PROJECT LEADER: TOBY BEN	DESIGNER: THUY VU		
	DRAFTSPERSON: THUY VU	CHECKED: TOBY BENNETT		
	APPROVED FOR AND ON BEH BURCHILLS ENGINEERING	S ABN 76 166 942 365		
		RPEQ No.: 8093	3	
	SCALE:	DATUM:	AHD	FULL SIZE : A1

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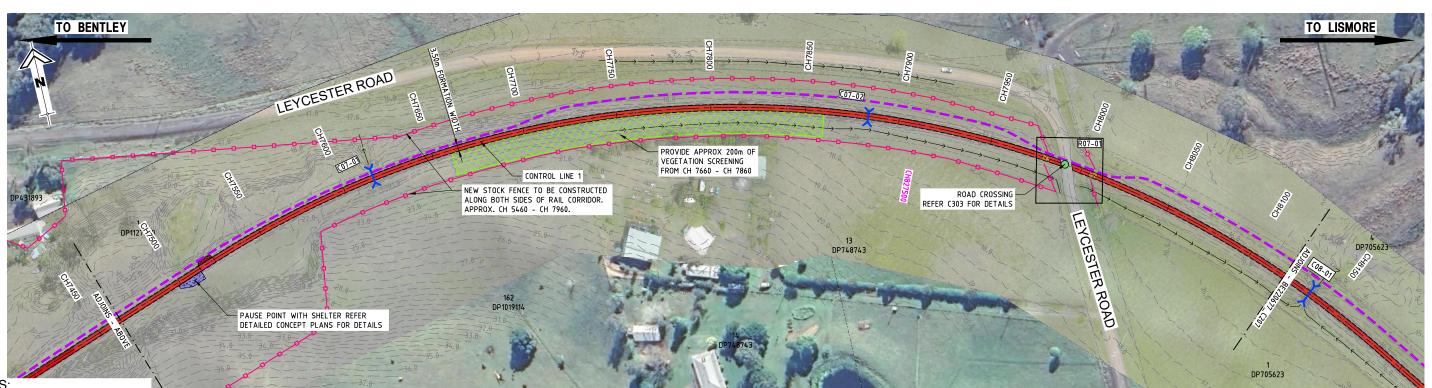
SCALE 10 0 10 20 30 40 50 (metres) 1 : 1000 (FULL SIZE)
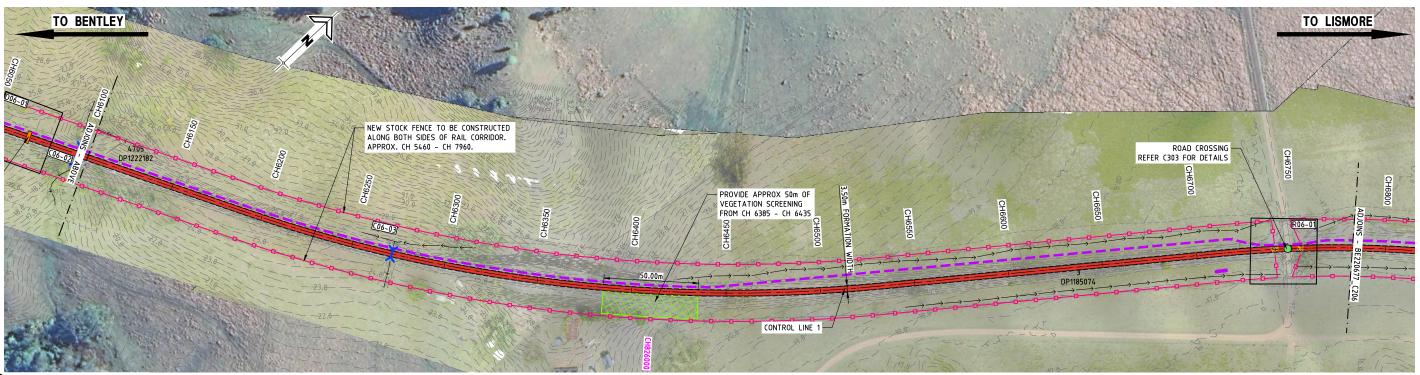
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PLAN

10 0 10 20 30 40 50 (metres)

1 : 1000 (FULL SIZE)

NORTHERN RIVERS RAIL TRAIL
BENTLEY TO LISMORE
LISMORE CITY COUNCIL

ISMORE CITY COUNCIL

A1 ORIGINAL SIZE BEFORE REDUCTION

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PROJECT.

NORTHERN RIVERS RAIL TRAIL - BENTLEY TO LISMORE DRAWING TITLE :

PLAN - SHEET 6

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PROJECT LEADER: TOBY BENNETT		DESIGNER:	THUY VU
DRAFTSPERSON: THUY VU		CHECKED:	TOBY BENNETT
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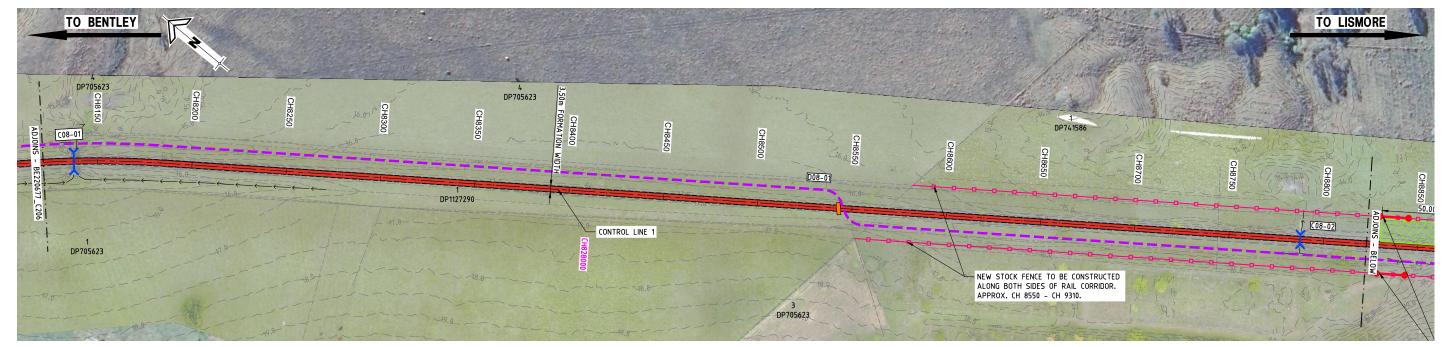
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SCALE: DATUM: AHD FULL SIZE: A1

PROJECT No.: DRAWING No.: VERSION:

BE220677 C206 A




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NORTHERN RIVERS RAIL TRAIL BENTLEY TO LISMORE

THE PRINCIPAL'S AUTHORISED PERSON.

LISMORE CITY COUNCIL lismore ORIGINAL SIZE BEFORE REDUCTION

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ESSENTIAL ENERGY'S REQUIREMENTS PRIOR TO COMMENCING WORK.

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Coote Burchills Engineering Pty Ltd ABN 76 166 942 365

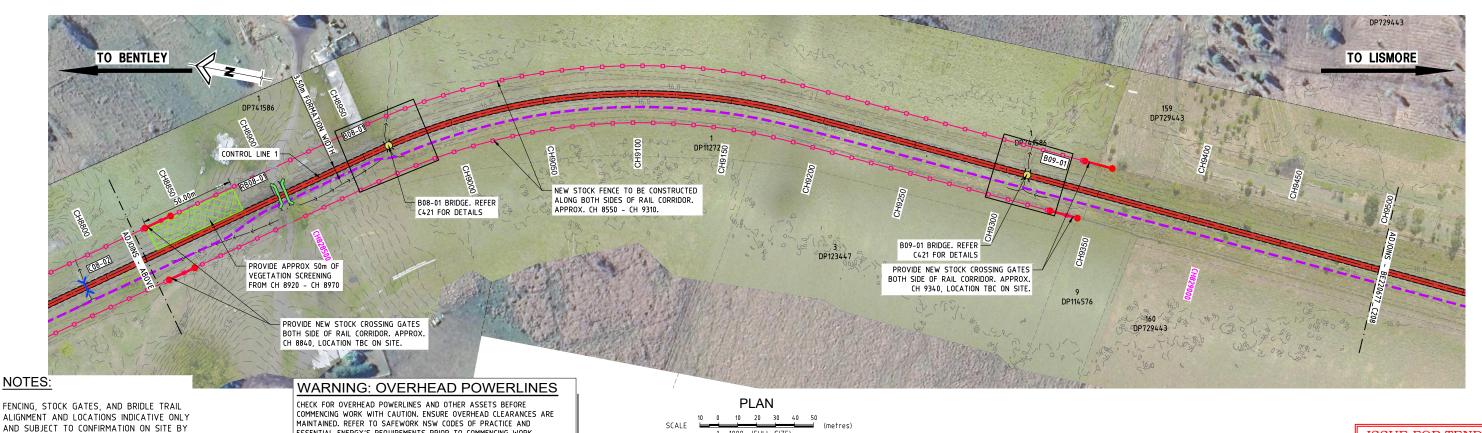
NORTHERN RIVERS RAIL TRAIL - BENTLEY TO LISMORE

DRAWING TITLE :

PLAN - SHEET 7

	ISSUE	FOR T	TENDER
DEVEL. APPLIC. No. :			DATE: 19-07-2023
PROJECT LEADER: TOB	Y BENNETT	DESIGNER: THUY VU	
DRAFTSPERSON: THUY VU		CHECKED: TOBY BENNETT	
APPROVED FOR AND OF			

SCALE : FULL SIZE : A1 PROJECT No BE220677 C207

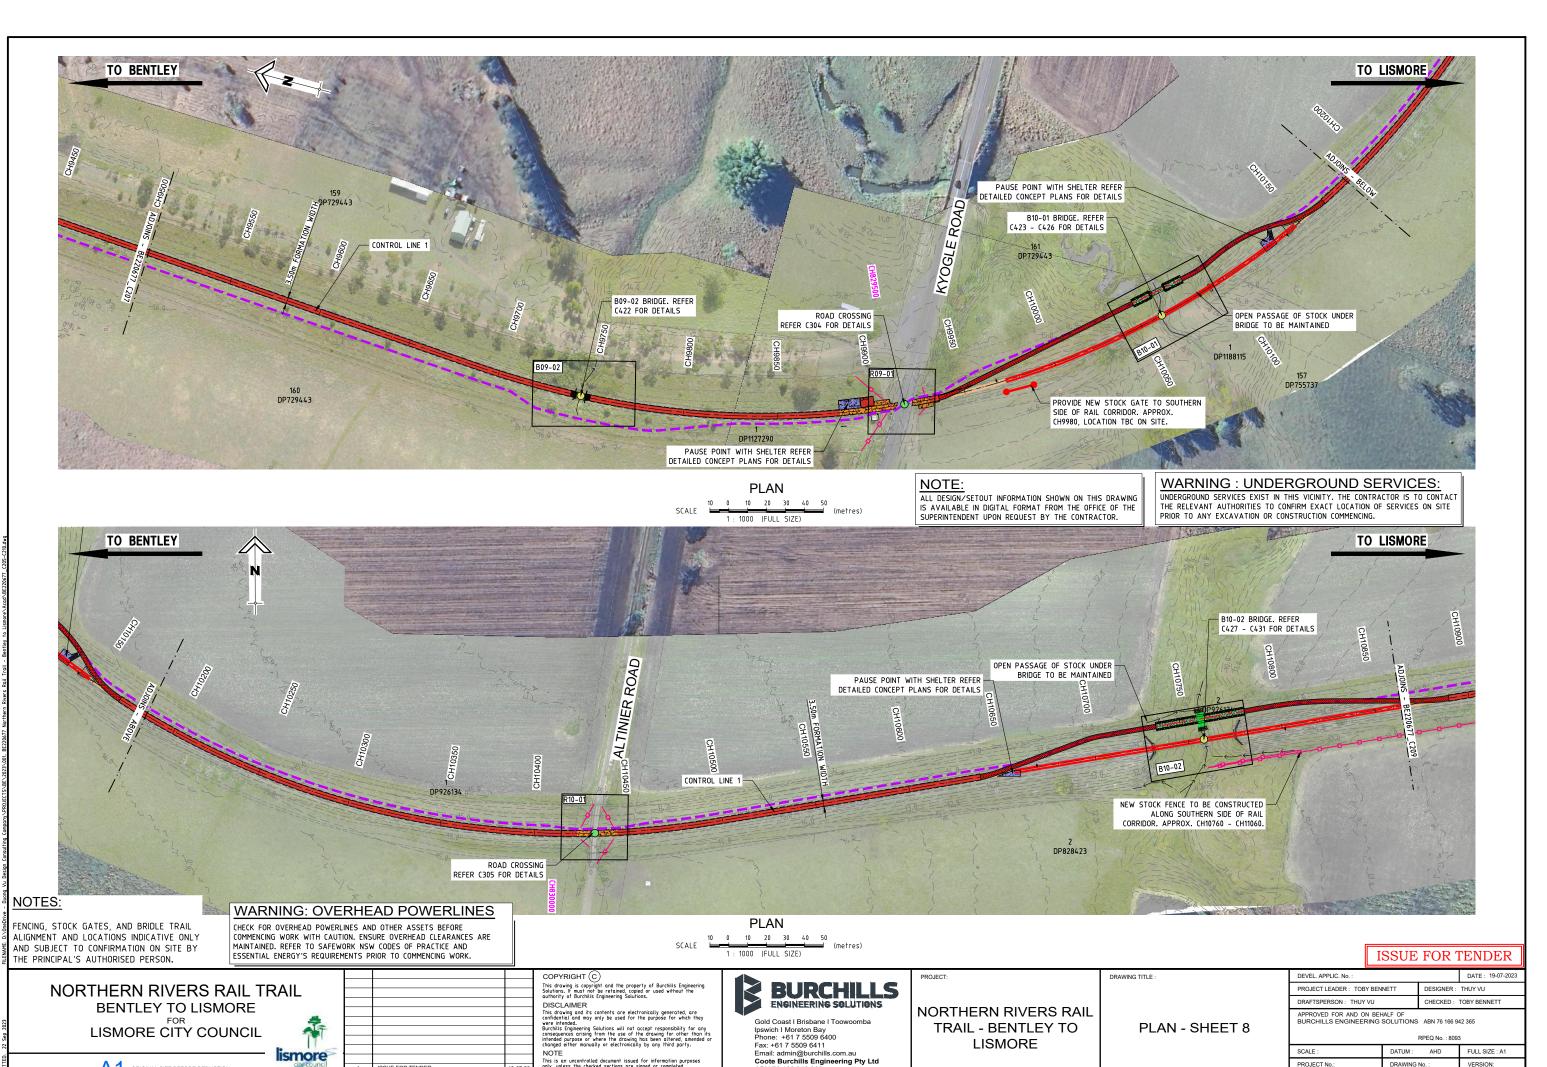

ABN 76 166 942 365

BE220677


C208

ORIGINAL SIZE BEFORE REDUCTION

ISSUE FOR TENDER





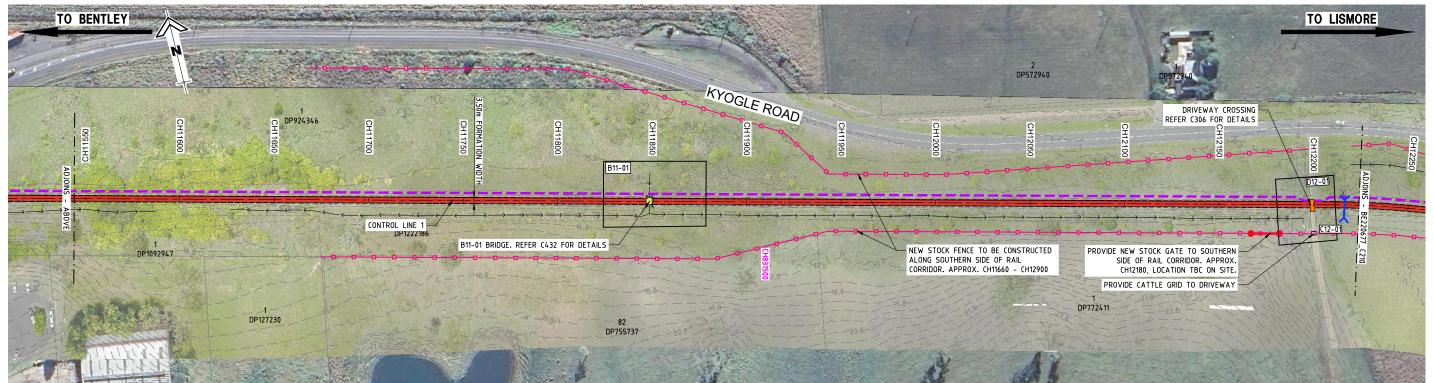

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PLAN 10 20 30 40 50

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ISSUE FOR TENDER

NORTHERN RIVERS RAIL TRAIL BENTLEY TO LISMORE LISMORE CITY COUNCIL



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Email: admin@burchills.com.au
Coote Burchills Engineering Pty Ltd ABN 76 166 942 365


NORTHERN RIVERS RAIL TRAIL - BENTLEY TO LISMORE

PLAN - SHEET 9

DRAWING TITLE :

1	SSUE	ruk i	LENDER
DEVEL. APPLIC. No. :			DATE: 19-07-2023
PROJECT LEADER: TOBY BEN	NETT	DESIGNER:	THUY VU
DRAFTSPERSON: THUY VU		CHECKED:	TOBY BENNETT
APPROVED FOR AND ON BEI BURCHILLS ENGINEERING		ABN 76 166 9	12 365
		RPEQ No.: 8093	3

AHD FULL SIZE : A1 BE220677 C209

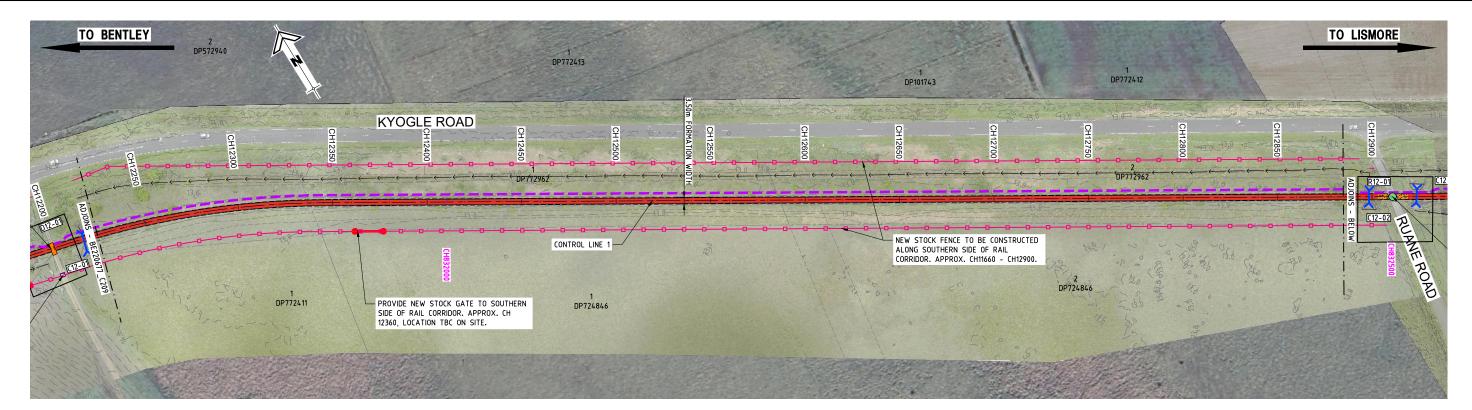





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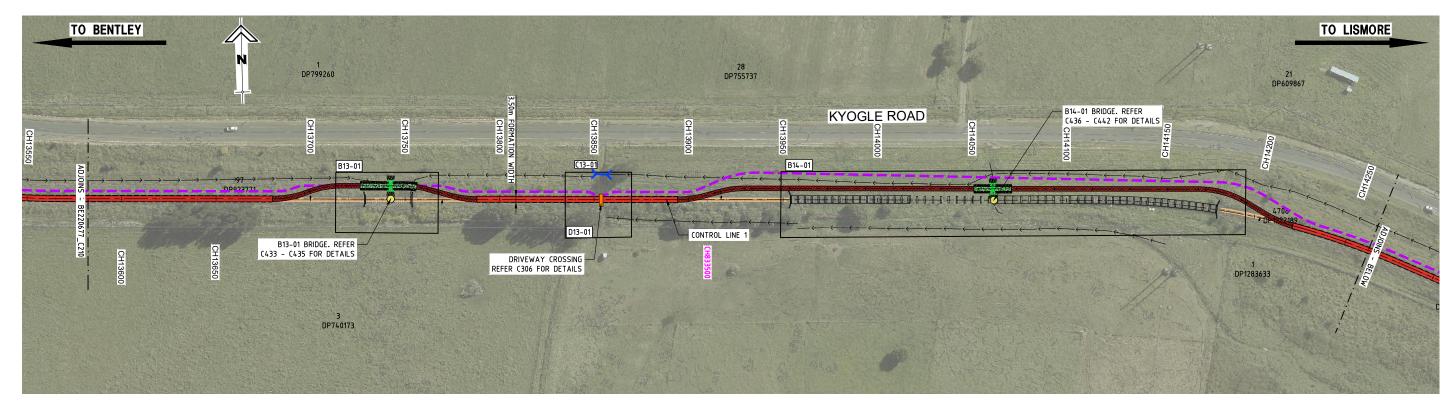
Coote Burchills Engineering Pty Ltd

ABN 76 166 942 365 NORTHERN RIVERS RAIL TRAIL - BENTLEY TO LISMORE


PLAN - SHEET 10

DRAWING TITLE :

	ISSUE	FOR 7	render
DEVEL. APPLIC. No. :			DATE: 19-07-2023
PROJECT LEADER: TOBY BENNETT		DESIGNER: THUY VU	
DRAFTSPERSON: THUY VU	CHECKED: TOBY BENNETT		
APPROVED FOR AND ON I BURCHILLS ENGINEERIN	ABN 76 166 9	42 365	
	RPEQ No.: 809	3	
SCALE:	DATUM:	AHD	FULL SIZE : A1
PROJECT No.: BE220677	C210		VERSION:





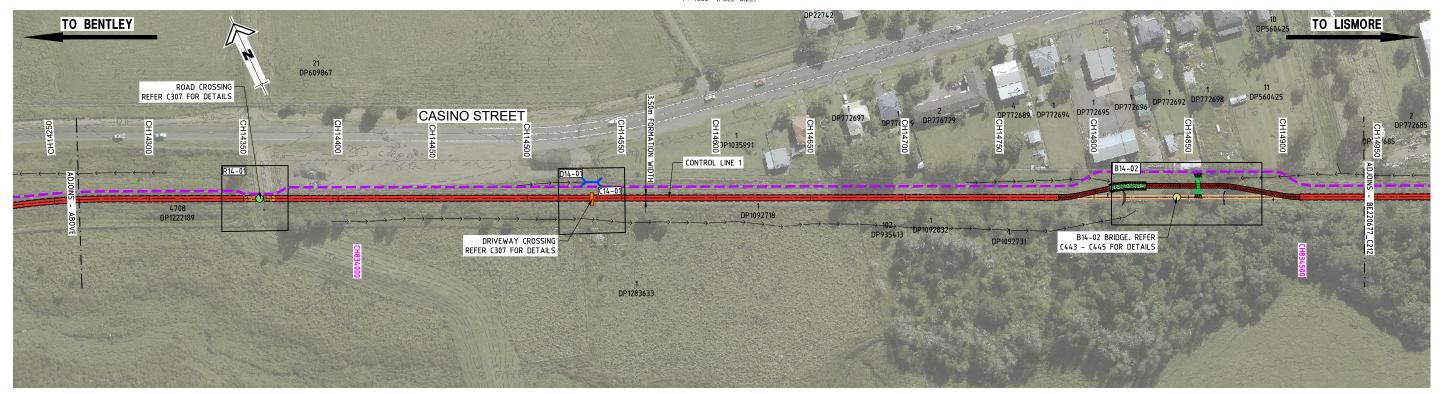

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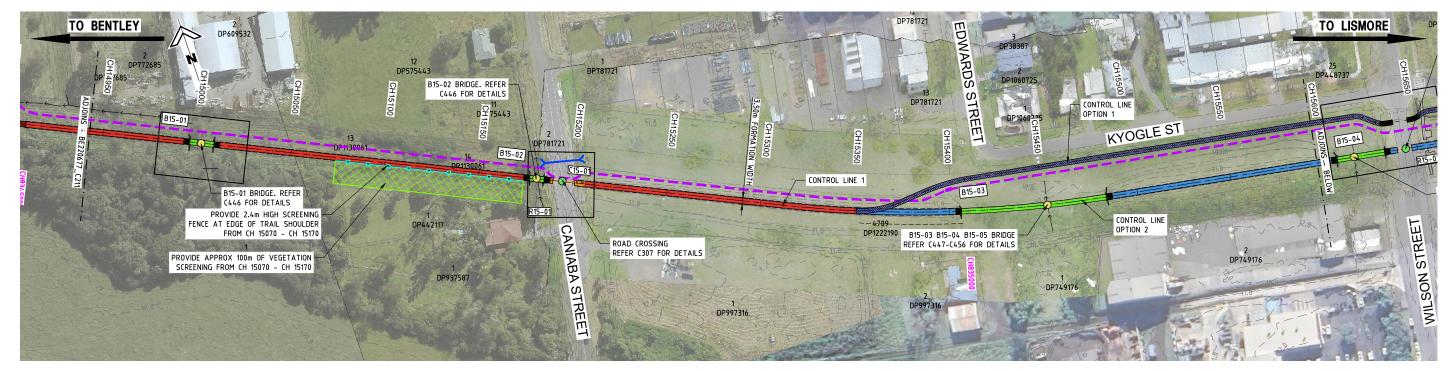
Coote Burchills Engineering Pty Ltd

ABN 76 166 942 365 NORTHERN RIVERS RAIL TRAIL - BENTLEY TO LISMORE


PLAN - SHEET 11

DRAWING TITLE :

	ISSUE	FOR 7	render	
DEVEL. APPLIC. No. :			DATE: 19-07-2023	
PROJECT LEADER: TOBY BENNETT		DESIGNER:	DESIGNER: THUY VU	
DRAFTSPERSON: THUY VU	CHECKED: TOBY BENNETT			
APPROVED FOR AND ON B BURCHILLS ENGINEERING	ABN 76 166 9	42 365		
	RPEQ No.: 8093	3		
SCALE:	DATUM :	AHD	FULL SIZE : A1	
PROJECT No.: BE220677	C21		VERSION:	





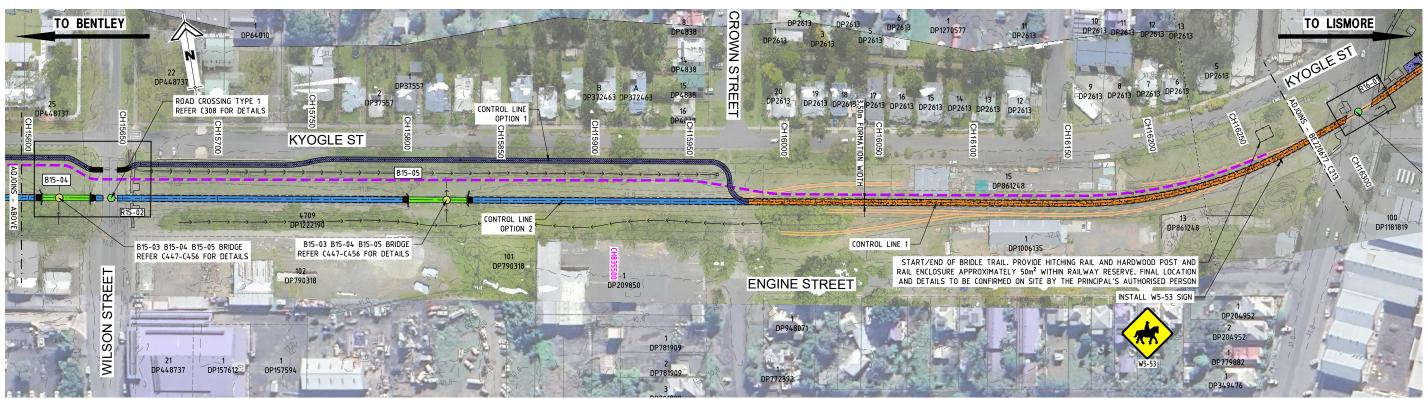

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PLAN 0 10 20 30 40 50

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I ICCITE EUD TENDED

FULL SIZE : A1

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NORTHERN RIVERS RAIL TRAIL - BENTLEY TO

PLAN - SHEET 12


DRAWING TITLE :

1330E	FOR	LENDER
DEVEL. APPLIC. No. :		DATE: 19-07-2023
PROJECT LEADER: TOBY BENNETT	DESIGNER:	THUY VU
DRAFTSPERSON: THUY VU	CHECKED:	TOBY BENNETT
APPROVED FOR AND ON BEHALF OF BURCHILLS ENGINEERING SOLUTIONS	42 365	
	RPEQ No.: 8093	3

C212

ORIGINAL SIZE BEFORE REDUCTION

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PLAN 10 20 30 1 : 1000 (FULL SIZE)
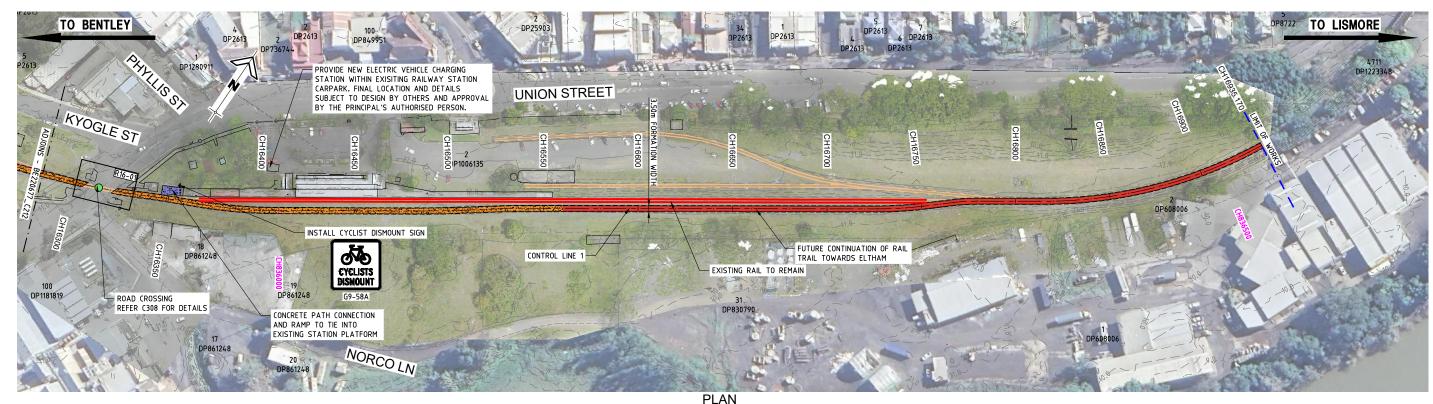
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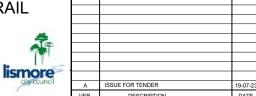
ORIGINAL SIZE BEFORE REDUCTION

NOTES:

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THE PRINCIPAL'S AUTHORISED PERSON.

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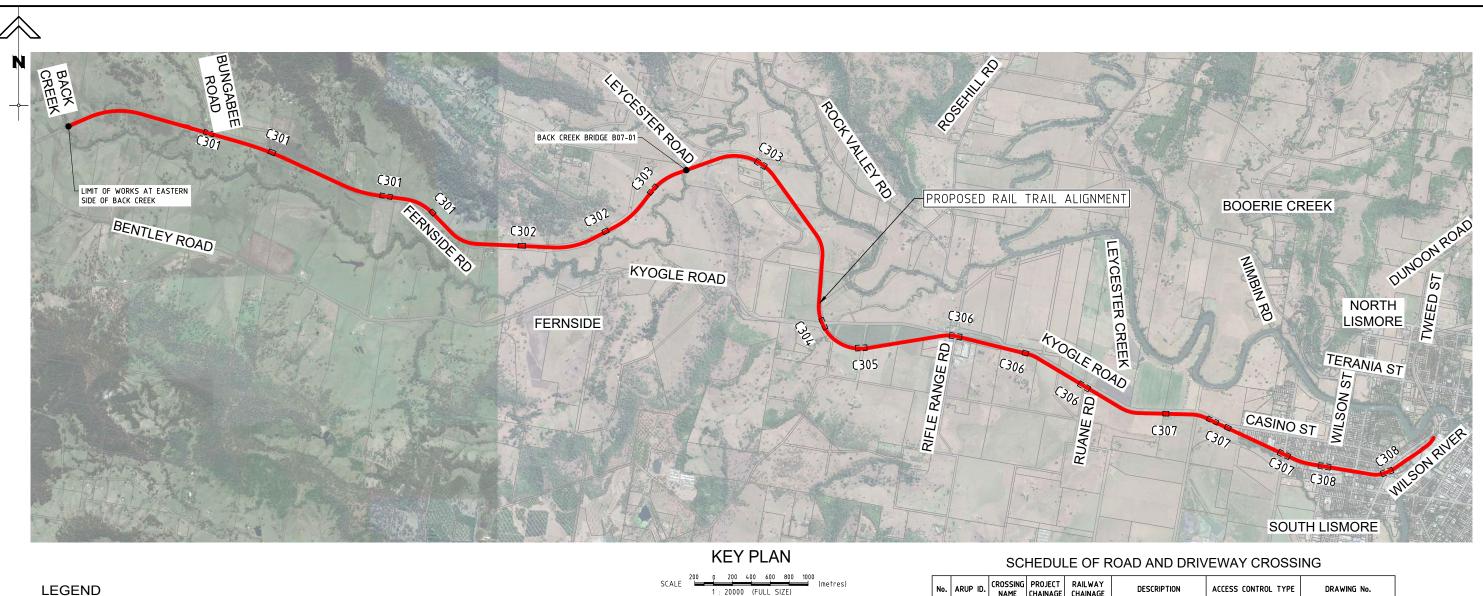
NORTHERN RIVERS RAIL TRAIL - BENTLEY TO LISMORE

PLAN - SHEET 13

DRAWING TITLE :

10002	1 011 12112211
DEVEL. APPLIC. No. :	DATE: 19-07-2023
PROJECT LEADER: TOBY BENNETT	DESIGNER: THUY VU
DRAFTSPERSON: THUY VU	CHECKED: TOBY BENNETT
APPROVED FOR AND ON BEHALF OF BURCHILLS ENGINEERING SOLUTIONS	ABN 76 166 942 365

FULL SIZE : A1 BE220677 C213



1 : 20000 (FULL SIZE)

No.	ARUP ID.	CROSSING NAME	PROJECT CHAINAGE	RAILWAY CHAINAGE	DESCRIPTION	ACCESS CONTROL TYPE	DRAWING No.
1	LX015	R01-01	CH1546	CH821136	ROAD CROSSING	TYPE 2 and TYPE 3	C301
2	LX016	D02-01	CH2246	CH821836	DRIVEWAY CROSSING	NONE	C301
3	LX017	R03-01	CH3045	CH822635	DRIVEWAY CROSSING	NONE	C301
4	LX018	D03-01	CH3545	CH823135	ROAD CROSSING	TYPE 3	C301
5	LX019	D04-01	CH4077	CH823667	DRIVEWAY CROSSING	NONE	C302
6	LX020	R05-01	CH5144	CH824734	ROAD CROSSING	TYPE 3	C302
7	LX021	D06-01	CH6070	CH825660	DRIVEWAY CROSSING	NONE	C302
8	LX022	R06-01	CH6748	CH826338	ROAD CROSSING	TYPE 3	C303
9	LX023	R07-01	CH7990	CH827580	ROAD CROSSING	TYPE 3	C303
10	LX025	R09-01	CH9917	CH829507	ROAD CROSSING	TYPE 3	C304
11	LX026	R10-01	CH10432	CH830022	ROAD CROSSING	TYPE 3	C305
12	LX027	R11-01	CH11440	CH831030	ROAD CROSSING	TYPE 1	C306
13	LX028	D12-01	CH12199	CH831789	DRIVEWAY CROSSING	NONE	C306
14	LX029	R12-01	CH12908	CH832498	ROAD CROSSING	TYPE 2	C306
15	LX032	D13-01	CH13854	CH833444	DRIVEWAY CROSSING	NONE	C306
16	-	D14-01	CH14358	CH833948	DRIVEWAY CROSSING	NONE	C307
17	LX033	R14-01	CH14534	CH834124	ROAD CROSSING	TYPE 2	C307
18	LX035	R15-01	CH15194	CH834784	ROAD CROSSING	TYPE 2	C307
19	LX036	R15-02	CH15644	CH835234	ROAD CROSSING	TYPE 2	C308
20	LX037	R16-01	CH16312	CH835902	ROAD CROSSING	TYPE 1	C308

NORTHERN RIVERS RAIL TRAIL BENTLEY TO LISMORE LISMORE CITY COUNCIL

EXISTING CONTOUR

EXISTING FENCE

→— EXISTING DRAIN

— W — — — W — — — EXISTING WATER MAIN

OH — — OH — — EXISTING ELECTRICAL

— — — — PROPERTY BOUNDARY

— s — — s — — EXISTING SEWER

 \bigcirc

EXISTING GUARDRAIL

EXISTING BUILDING

EXISTING TELSTRA

EXISTING CULVERT

EXISTING ROAD LEVEL CROSSING

EXISTING DRIVEWAY CROSSING


EXISTING RAILWAY BRIDGE EXISTING ROAD OVERBRIDGE

EXISTING BALLAST BATTER

_________EXISTING BATTER

EXISTING RAIL TO BE REMOVED

EXISTING RAIL TO BE REMAIN

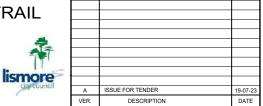

PROPOSED STOCK FENCE WITH STOCK GATE

PROPOSED SWALE DRAIN

PROPOSED BYPASS CENTERLINE

— – — PROPOSED CONTROL LINE

UNSEALED

CONCRETE

CONCRETE

CONCRETE

UNSEALED

PROJECT CHAINAGE

Y___Y__Y_ PROPOSED BATTER

- CH1740

- CH819500

16.83

PROPOSED 2.4m HIGH SCREENING FENCE

BRIDLE PATH (INDICATIVE ALIGNMENT)

RAILWAY CHAINAGE (KM FROM SYDNEY)

PROPOSED RAIL TRAIL - SEALED

PROPOSED RAIL TRAIL - UNSEALED

PROPOSED RAIL TRAIL - BYPASS

PROPOSED RAIL TRAIL - BYPASS

PROPOSED RAIL TRAIL - BYPASS

PROPOSED RAIL TRAIL - ON-LINE BRIDGE PROPOSED RAIL TRAIL - ON-FORMATION

PROPOSED RAIL TRAIL - OFF-FORMATION

PROPOSED RAIL TRAIL - OFF-FORMATION

PROPOSED RAIL TRAIL OFF-FORMATION

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ABN 76 166 942 365

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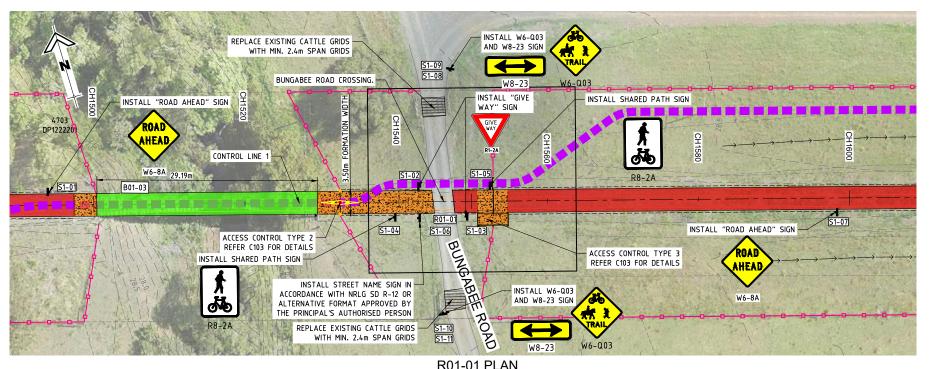
RAIL TRAIL ROAD, **DRIVEWAY CROSSING KEY PLAN**


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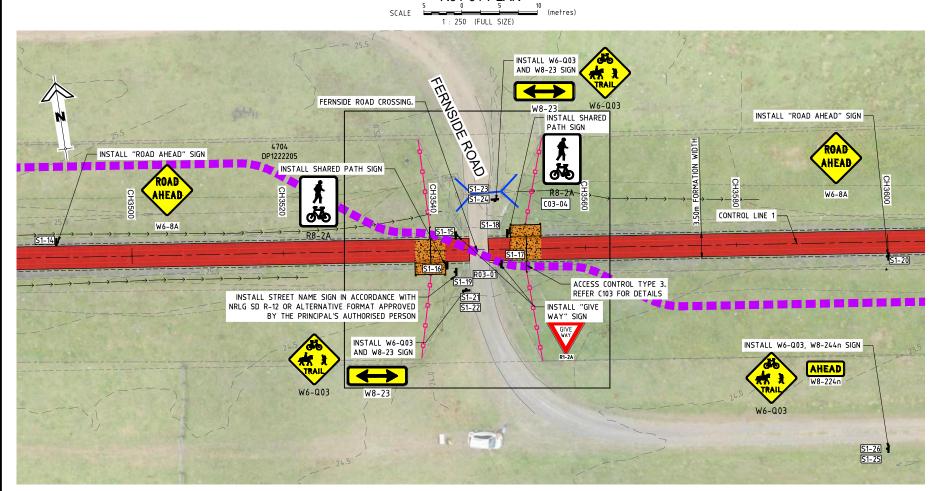
	ISSUE	FOR 7	TENDER
DEVEL. APPLIC. No. :			DATE: 19-07-2023
PROJECT LEADER: TOBY BENNETT		DESIGNER:	THUY VU
 DRAFTSPERSON: THUY	VU	CHECKED:	TOBY BENNETT


APPROVED FOR AND ON BEHALF OF BURCHILLS ENGINEERING SOLUTIONS ABN 76 166 942 365

RPEQ No.: 8093 AHD FULL SIZE : A1 BE220677 C300





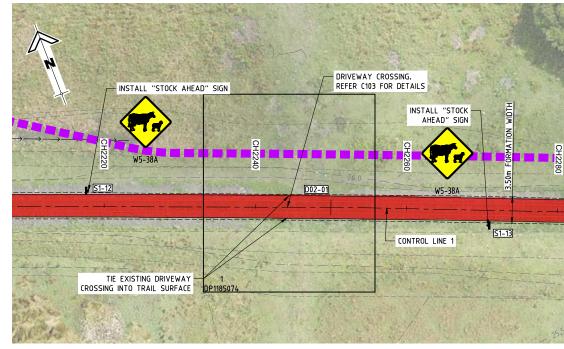

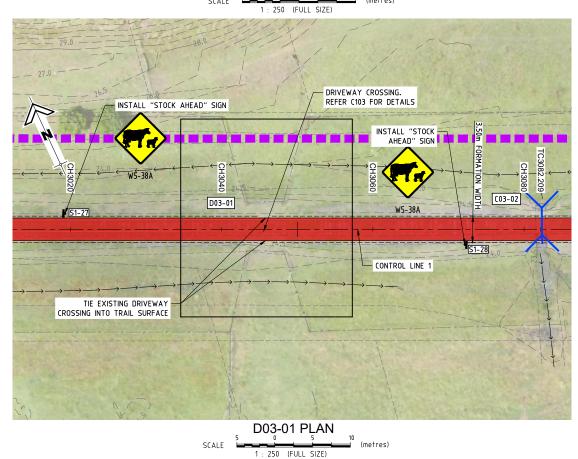

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NORTHERN RIVERS RAIL


DRIVEWAY CROSSING PLAN -SHEET 1


	ISSUE	TENDER	
DEVEL. APPLIC. No. :			DATE: 19-07-2023
PROJECT LEADER: TOB	Y BENNETT	DESIGNER:	THUY VU
DRAFTSPERSON: THUY	VU	CHECKED:	TOBY BENNETT
APPROVED FOR AND O		ADN 70 400 0	40.005

AHD FULL SIZE : A1 BE220677 C301

ORIGINAL SIZE BEFORE REDUCTION


TRAIL - BENTLEY TO LISMORE

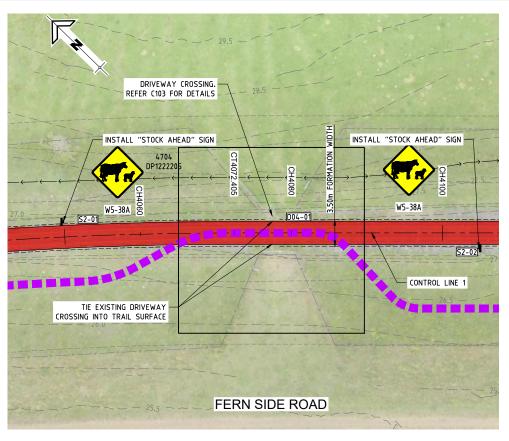

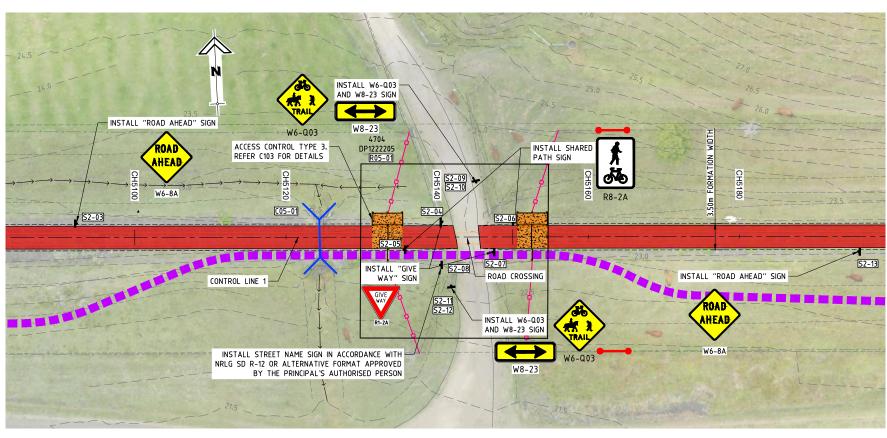





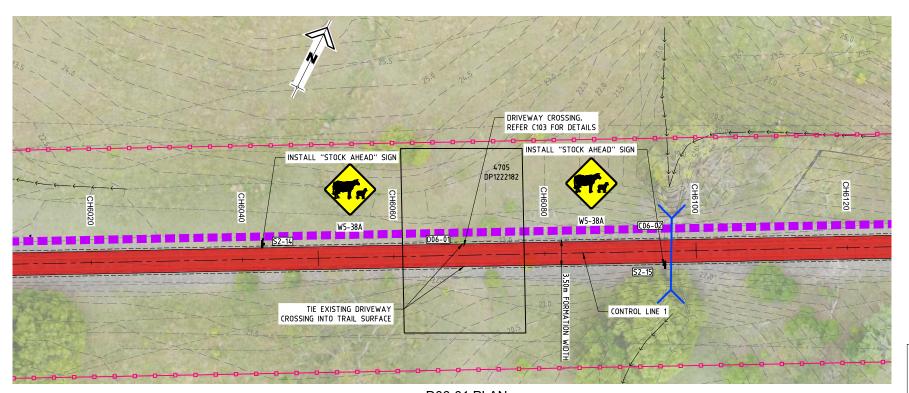

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NORTHERN RIVERS RAIL TRAIL - BENTLEY TO

DRIVEWAY CROSSING PLAN -SHEET 2

DRAWING TITLE :

DEVEL. APPLIC. No. :		DATE: 19-07-2023
PROJECT LEADER: TOBY BENNETT	DESIGNER:	THUY VU
DRAFTSPERSON: THUY VU	CHECKED:	TOBY BENNETT
ADDDOVED FOR AND ON DELINE OF		•


APPROVED FOR AND ON BEHALF OF BURCHILLS ENGINEERING SOLUTIONS ABN 76 166 942 365 AHD FULL SIZE : A1

C302

ORIGINAL SIZE BEFORE REDUCTION

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R07-01 PLAN 1 : 250 (FULL SIZE)

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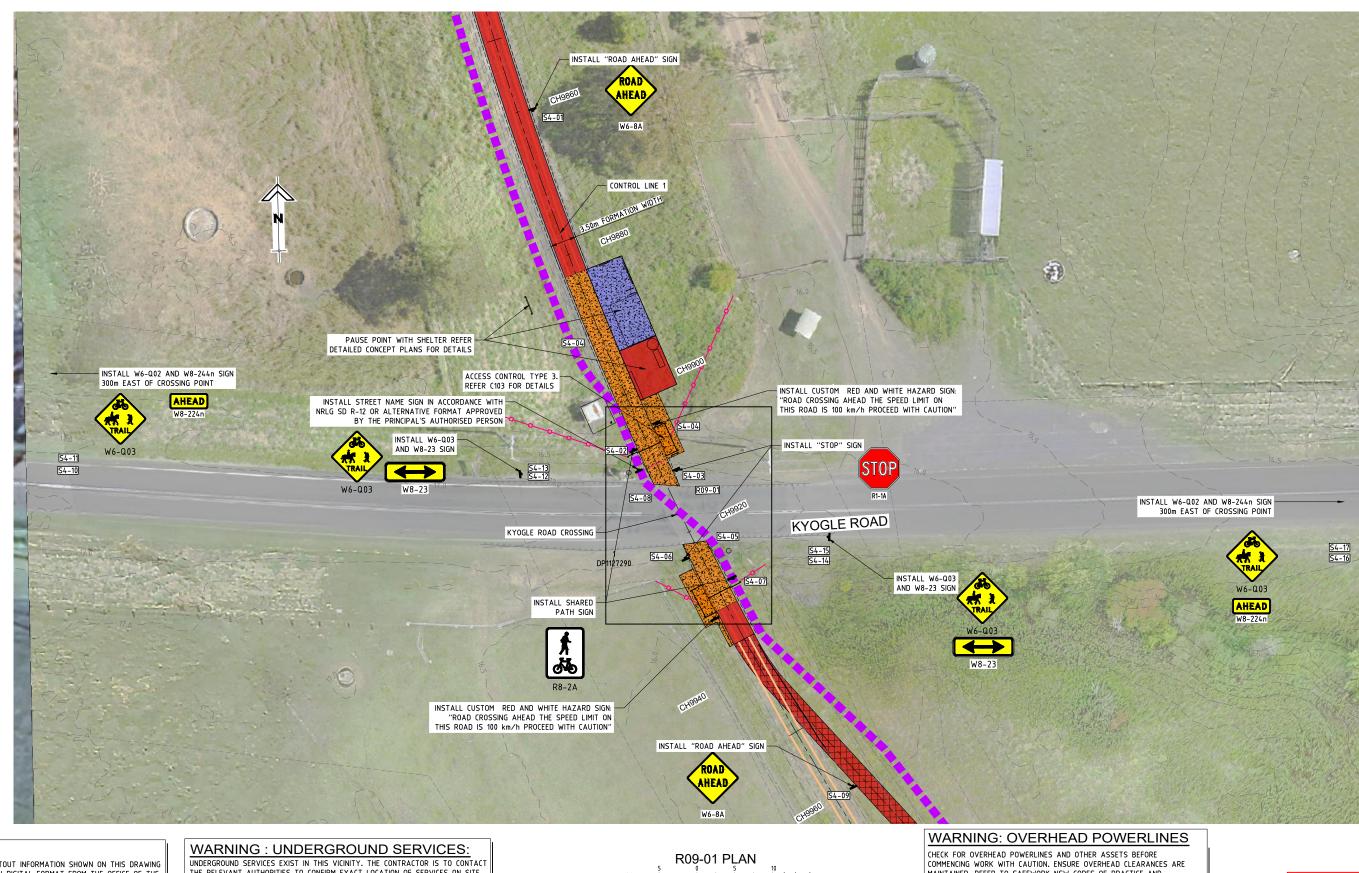
DRIVEWAY CROSSING PLAN -SHEET 3

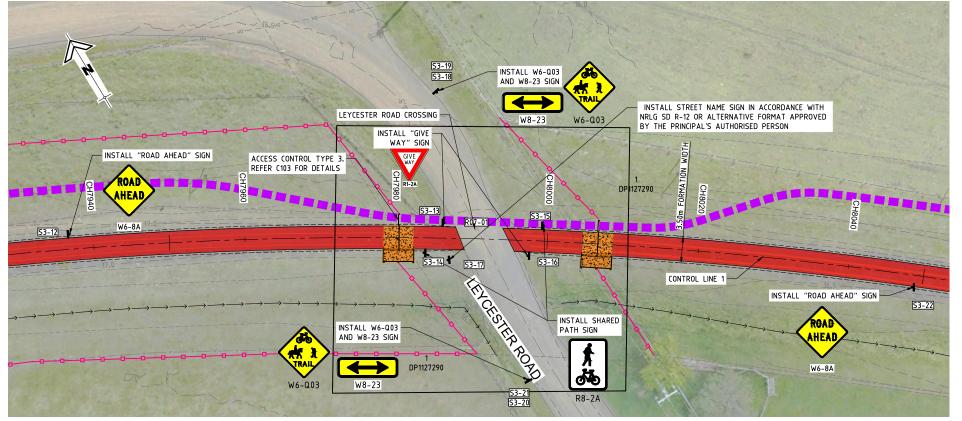DRAWING TITLE :

	ISSUE FOR 7	TENDER
C. No. :		DATE: 19-07-202

PROJECT LEADER: TOBY BENNET DRAFTSPERSON: THUY VU CHECKED: TOBY BENNETT

SCALE : AHD FULL SIZE : A1 BE220677 C303



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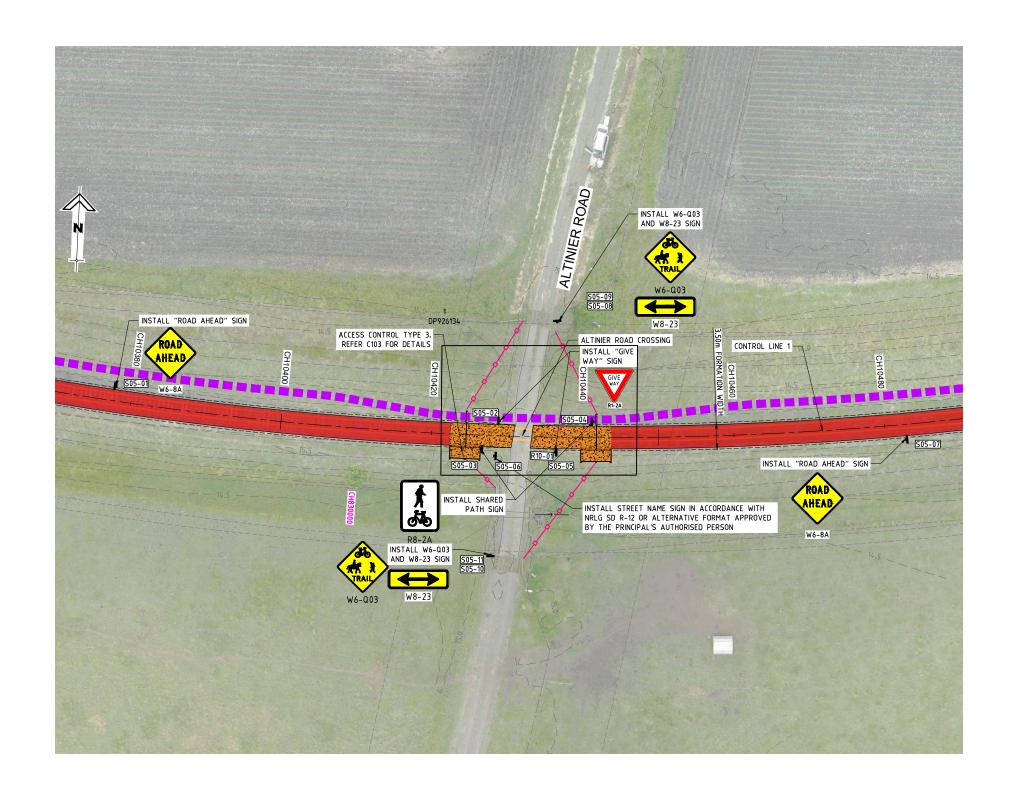
ABN 76 166 942 365

NORTHERN RIVERS RAIL TRAIL - BENTLEY TO LISMORE

DRIVEWAY CROSSING PLAN -SHEET 4

	ISSUE	FOR 7	render
DEVEL. APPLIC. No. :			DATE: 19-07-202
PROJECT LEADER: TOBY BENNETT		DESIGNER:	THUY VU
DRAFTSPERSON: THUY VU		CHECKED:	TOBY BENNETT

AHD FULL SIZE : A1 BE220677 C304



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NORTHERN RIVERS RAIL TRAIL
BENTLEY TO LISMORE
LISMORE CITY COUNCIL

Y COUNCIL lismore

Α	ISSUE FOR TENDER	19-07-23
VER.	DESCRIPTION	DATE

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BURCHILLS ENGINEERING SOLUTIONS

Gold Coast I Brisbane I Toowoomba Ipswich I Moreton Bay Phone: +617 5509 6400 Fax: +617 5509 6411 Email: admin@burchills.com.au Coote Burchills Engineering Pty Ltd ABN 76 166 942 365 PROJECT

NORTHERN RIVERS RAIL TRAIL - BENTLEY TO LISMORE DRAWING TITLE :

DRIVEWAY CROSSING PLAN -SHEET 5

	ISSUE FOR 7	render
_		

DEVEL APPLIC. No.:

DATE: 19-07-20

PROJECT LEADER: TOBY BENNETT

DESIGNER: THUY VU

DRAFTSPERSON: THUY VU

CHECKED: TOBY BENNETT

APPROVED FOR AND ON BEHALF OF
BURCHILLS ENGINEERING SOLUTIONS ABN 76 166 942 365


 RPEQ No.: 8093


 SCALE:
 DATUM:
 AHD
 FULL SIZE: A1


 PROJECT No.:
 DRAWING No.:
 VERSION:

 BE220677
 C305
 A

1 -----

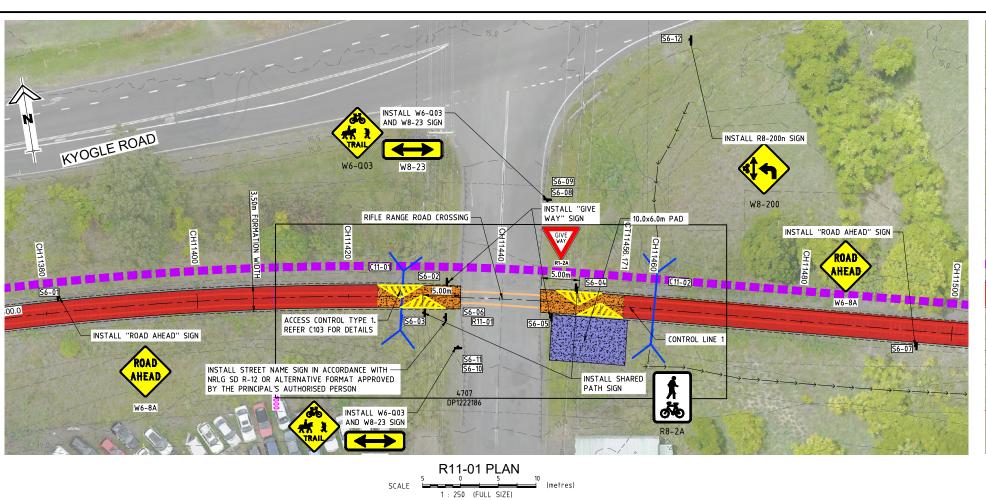


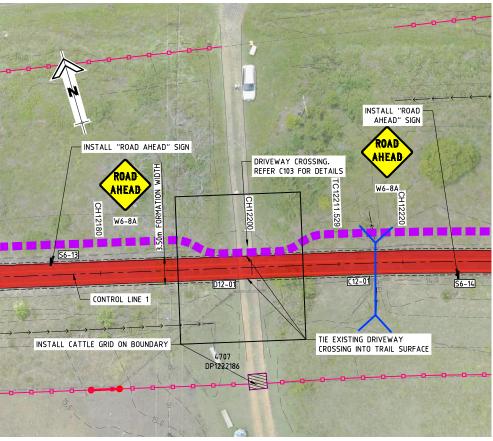

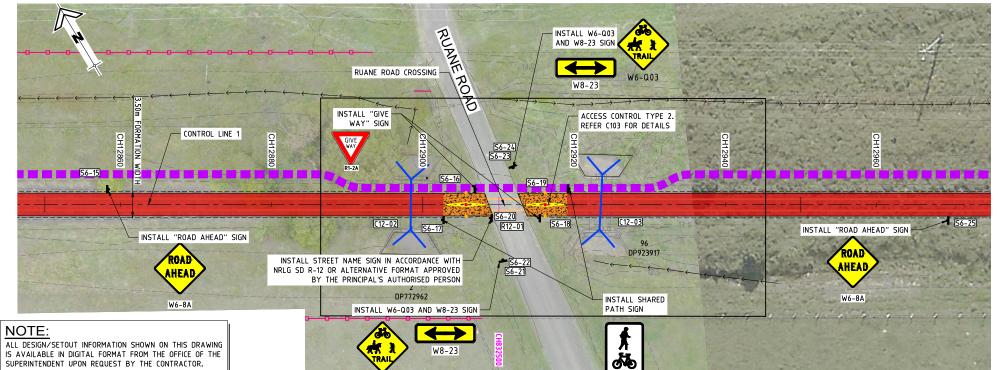

R12-01 PLAN



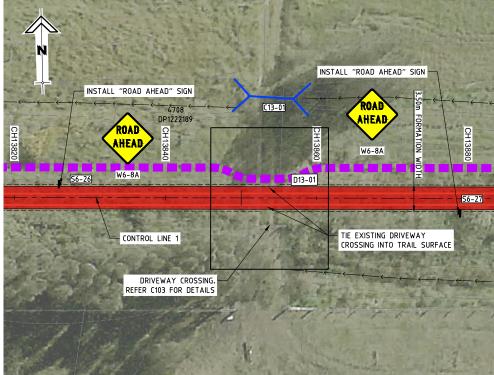

D13-01 PLAN

NORTHERN RIVERS RAIL TRAIL BENTLEY TO LISMORE


WARNING: UNDERGROUND SERVICES:

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LISMORE CITY COUNCIL

lismore

ORIGINAL SIZE BEFORE REDUCTION

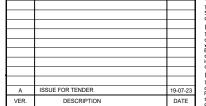

DISCLAIMER

Ipswich I Moreton Bay Phone: +61 7 5509 6400 Fax: +61 7 5509 6411 Email: admin@burchills.com.au
Coote Burchills Engineering Pty Ltd

ABN 76 166 942 365

DRIVEWAY CROSSING PLAN -

SHEET 6


DRAWING TITLE :


IZE)	(metres)	ISSUE FOR TENDER			
	DEVEL. APPLIC. No. :			DATE: 19-07-2023	
	PROJECT LEADER: TOBY BEN	DESIGNER:	THUY VU		
	DRAFTSPERSON: THUY VU			CHECKED: TOBY BENNETT	
	APPROVED FOR AND ON BEH BURCHILLS ENGINEERING	ABN 76 166 94	42 365		
		RPEQ No.: 8093	3		
	SCALE:	DATUM:	AHD	FULL SIZE : A1	
	PROJECT No.: DRAWING C300			VERSION:	

WARNING: OVERHEAD POWERLINES

CHECK FOR OVERHEAD POWERLINES AND OTHER ASSETS BEFORE COMMENCING WORK WITH CAUTION. ENSURE OVERHEAD CLEARANCES ARE MAINTAINED. REFER TO SAFEWORK NSW CODES OF PRACTICE AND ESSENTIAL ENERGY'S REQUIREMENTS PRIOR TO COMMENCING WORK.

NORTHERN RIVERS RAIL TRAIL - BENTLEY TO LISMORE

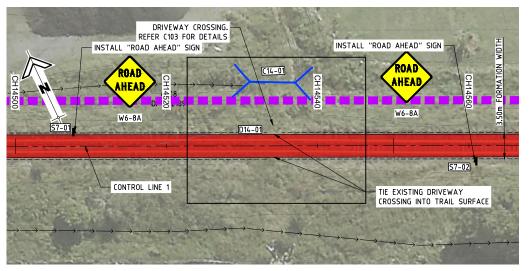


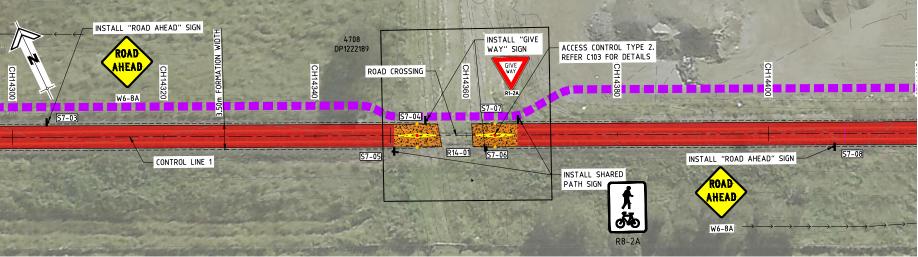

R14-01 PLAN

5 0 5 10

SCALE 1: 250 (FUIL SIZE) (metre

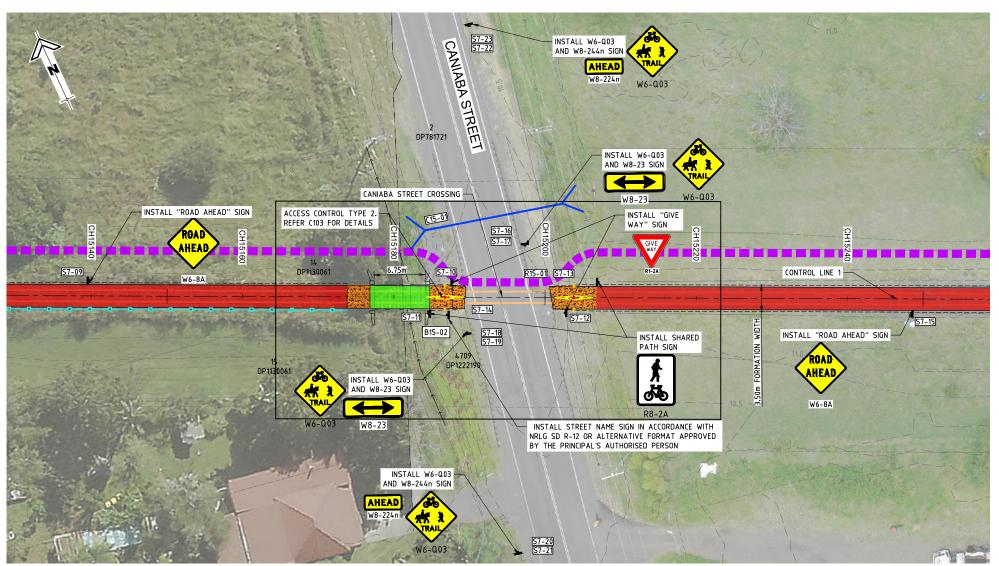

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ISSUE FOR TENDER

NORTHERN RIVERS RAIL TRAIL
BENTLEY TO LISMORE
LISMORE CITY COUNCIL

NCIL lismore

A ISSUE FOR TENDER 19-07-2:
VER. DESCRIPTION DATE

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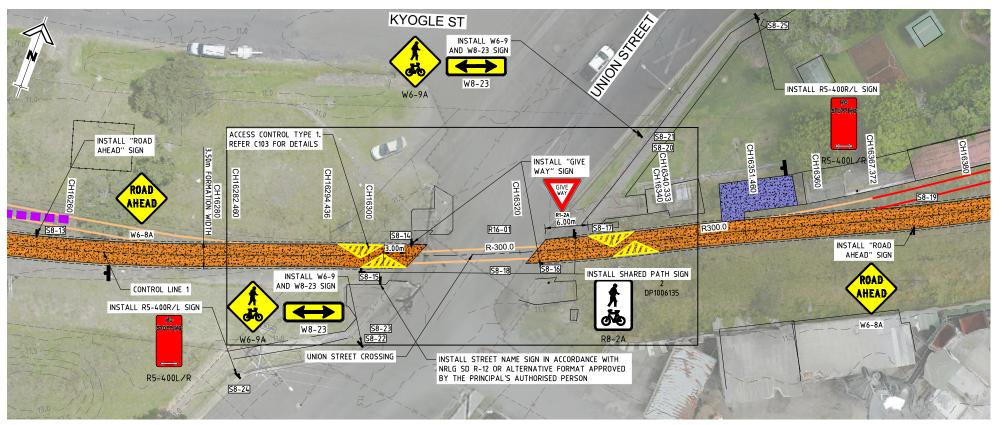
BURCHILLS ENGINEERING SOLUTIONS

Gold Coast I Brisbane I Toowoomba Ipswich I Moreton Bay Phone: +61 7 5509 6400 Fax: +61 7 5509 6411 Email: admin@burchills.com.au Coote Burchills Engineering Pty Ltd ABN 76 166 942 365 NORTHERN RIVERS RAIL TRAIL - BENTLEY TO LISMORE DRIVEWAY CROSSING PLAN -SHEET 7

DRAWING TITLE :

	DEVEL. APPLIC. No. :		DATE: 19-07-2
	PROJECT LEADER: TOBY BENNETT	DESIGNER:	THUY VU
-14/41/	DRAFTSPERSON: THUY VU	CHECKED:	TOBY BENNETT
EWAY	APPROVED FOR AND ON BEHALF OF BURCHILLS ENGINEERING SOLUTIONS	ABN 76 166 9	12 365
10 DI 441	BURCHILLS ENGINEERING SOLUTIONS	ABN 76 166 94	12 365





R16-01 PLAN 1 : 250 (FULL SIZE)

NOTE:

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ISSUE FOR TENDER

NORTHERN RIVERS RAIL TRAIL BENTLEY TO LISMORE LISMORE CITY COUNCIL

lismore

ISSUE FOR TENDER

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Gold Coast I Brisbane I Toow Ipswich I Moreton Bay Phone: +61 7 5509 6400 Fax: +61 7 5509 6411 Email: admin@burchills.com.au
Coote Burchills Engineering Pty Ltd ABN 76 166 942 365

NORTHERN RIVERS RAIL TRAIL - BENTLEY TO

LISMORE

DRIVEWAY CROSSING PLAN -SHEET 8

DRAWING TITLE :

10001	, , отс	121122
DEVEL. APPLIC. No. :		DATE: 19-07-
PROJECT LEADER: TOBY BENNETT	DESIGNER:	THUY VU

DRAFTSPERSON: THUY VU

AHD FULL SIZE : A1 BE220677 C308

SIGN No.	SIGN ID	SIGN CODE	TYPE/DESCRIPTION	DETAILS
1	S1-01	W6-8A	ROAD AHEAD	MOUNT ON POST
2	S1-02	R1-2A	GIVE WAY	MOUNT ON POST
3	S1-03	R1-2A	GIVE WAY	MOUNT ON POST
4	S1-04	R8-2A	SHARED PATH	MOUNT ON POST
5	S1-05	R8-2A	SHARED PATH	MOUNT ON POST
6	S1-06	W6-8A	STREET NAME	MOUNT ON POST
7	S1-07	W6-8A	ROAD AHEAD	MOUNT ON POST
8	S1-08	W6-Q03	TRAIL CROSSING	MOUNT ON POST
9	S1-09	W8-23	ARROW SUPPLEMENTARY PLATE	MOUNT BELOW SIGN S1-07
10	S1-10	W6-Q03	TRAIL CROSSING	MOUNT ON POST
11	S1-11	W8-23	ARROW SUPPLEMENTARY PLATE	MOUNT BELOW SIGN S1-09
12	S1-12	W5-38A	STOCK AHEAD	MOUNT ON POST
13	S1-13	W5-38A	STOCK AHEAD	MOUNT ON POST
14	S1-14	W6-8A	ROAD AHEAD	MOUNT ON POST
15	S1-15	R1-2A	GIVE WAY	MOUNT ON POST
16	S1-16	R8-2A	SHARED PATH	MOUNT ON POST
17	S1-17	R1-2A	GIVE WAY	MOUNT ON POST
18	S1-18	R8-2A	SHARED PATH	MOUNT ON POST
19	S1-19	W6-Q03	STREET NAME	MOUNT ON POST
20	S1-20	W6-8A	ROAD AHEAD	MOUNT ON POST
21	S1-21	W6-Q03	TRAIL CROSSING	MOUNT ON POST
22	S1-22	W8-23	ARROW SUPPLEMENTARY PLATE	MOUNT BELOW SIGN S1-19
23	S1-23	W6-Q03	TRAIL CROSSING	MOUNT ON POST
24	S1-24	W8-23	ARROW SUPPLEMENTARY PLATE	MOUNT BELOW SIGN S1-21
25	S1-25	W6-Q03	TRAIL CROSSING	MOUNT ON POST
26 27	S1-26 S1-27	W8-244n W5-38A	AHEAD	MOUNT BELOW SIGN S4-23 MOUNT ON POST
28	S1-27 S1-28	W5-38A	STOCK AHEAD STOCK AHEAD	MOUNT ON POST
29	S2-01	W5-38A	STOCK AHEAD	MOUNT ON POST
30	S2-01	W5-38A	STOCK AHEAD	MOUNT ON POST
31	S2-02	W6-8A	ROAD AHEAD	MOUNT ON POST
32	S2-04	R1-2A	GIVE WAY	MOUNT ON POST
33	S2-05	R8-2A	SHARED PATH	MOUNT ON POST
34	S2-06	R1-2A	GIVE WAY	MOUNT ON POST
35	S2-07	R8-2A	SHARED PATH	MOUNT ON POST
36	52-08	W6-Q03	STREET NAME	MOUNT ON POST
37	S2-09	W6-Q03	TRAIL CROSSING	MOUNT ON POST
38	S2-10	W8-23	ARROW SUPPLEMENTARY PLATE	MOUNT BELOW SIGN S2-08
39	S2-11	W6-Q03	TRAIL CROSSING	MOUNT ON POST
40	S2-12	W8-23	ARROW SUPPLEMENTARY PLATE	MOUNT BELOW SIGN S2-10
41	S2-13	W6-8A	ROAD AHEAD	MOUNT ON POST
42	S2-14	W5-38A	STOCK AHEAD	MOUNT ON POST
43	S2-15	W5-38A	STOCK AHEAD	MOUNT ON POST
44	S3-01	W6-8A	ROAD AHEAD	MOUNT ON POST
45	S3-02	R1-2A	GIVE WAY	MOUNT ON POST
46	S3-03	R8-2A	SHARED PATH	MOUNT ON POST
47	S3-04	R1-2A	GIVE WAY	MOUNT ON POST
48	S3-05	R8-2A	SHARED PATH	MOUNT ON POST
49	S3-06	W8-23	STREET NAME	MOUNT ON POST
50 E1	S3-07	W6-Q03	TRAIL CROSSING	MOUNT ON POST
51 52	S3-08 S3-09	W8-23	ARROW SUPPLEMENTARY PLATE TRAIL CROSSING	MOUNT BELOW SIGN S3-06
52 53	S3-09 S3-10	W6-Q03 W8-23	ARROW SUPPLEMENTARY PLATE	MOUNT ON POST MOUNT BELOW SIGN S3-08
54	S3-10 S3-11	W6-8A	ROAD AHEAD	MOUNT ON POST
55	S3-12	W6-8A	ROAD AHEAD	MOUNT ON POST
56	S3-12	R1-2A	GIVE WAY	MOUNT ON POST
57	S3-14	R8-2A	SHARED PATH	MOUNT ON POST
58	S3-15	R1-2A	SHARED PATH	MOUNT ON POST
59	S3-16	R8-2A	GIVE WAY	MOUNT ON POST
60	S3-17	W6-8A	ROAD AHEAD	MOUNT ON POST
61	S3-18	W6-8A	STREET NAME	MOUNT ON POST
62	S3-19	W6-Q03	TRAIL CROSSING	MOUNT BELOW SIGN S3-16
			•	

SIGN No.	SIGN ID	SIGN CODE	TYPE/DESCRIPTION	DETAILS
63	S3-20	W8-23	ARROW SUPPLEMENTARY PLATE	MOUNT ON POST
64	S3-21	W6-Q03	TRAIL CROSSING MOUNT BELOW SIG	
65	S3-22	W8-23	ARROW SUPPLEMENTARY PLATE	MOUNT ON POST
66	S4-01	W6-8A	ROAD AHEAD	MOUNT ON POST
67	S4-02	R8-2A	SHARED PATH	MOUNT ON POST
68	S4-03	R1-1A	STOP	MOUNT ON POST
69	S4-04	CUSTOM HAZARD SIGN	MOUNT ON POST	MOUNT ON POST
70	S4-05	R1-1A	SHARED PATH	MOUNT ON POST
71	S4-06	R8-2A	STOP	MOUNT ON POST
72	S4-07	CUSTOM HAZARD SIGN	MOUNT ON POST	MOUNT ON POST
73	S4-08	W6-Q03	STREET NAME	MOUNT ON POST
74	S4-09	W6-8A	ROAD AHEAD	MOUNT ON POST
75	S4-10	W6-Q03	TRAIL CROSSING	MOUNT ON POST
76	S4-11	W8-244n	AHEAD	MOUNT BELOW SIGN S4-07
77	S4-12	W6-Q03	TRAIL CROSSING	MOUNT ON POST
78	S4-13	W8-23	ARROW SUPPLEMENTARY PLATE	MOUNT BELOW SIGN S4-09
79	S4-14	W6-Q03	TRAIL CROSSING	MOUNT ON POST
80	S4-15	W8-23	ARROW SUPPLEMENTARY PLATE	MOUNT BELOW SIGN S4-11
81	S4-16	W6-Q03	TRAIL CROSSING	MOUNT ON POST
82	S4-17	W8-244n	AHEAD	MOUNT BELOW SIGN S4-13
83	S05-01	W6-8A	ROAD AHEAD	MOUNT ON POST
84	S05-02	R1-2A	GIVE WAY	MOUNT ON POST
85	S05-03	R8-2A	SHARED PATH	MOUNT ON POST
86	S05-04	R8-2A	SHARED PATH	MOUNT ON POST
87	S05-05	R1-2A	GIVE WAY	MOUNT ON POST
88	S05-06	R1-2A	STREET NAME	MOUNT ON POST
89	S05-07	W6-8A	ROAD AHEAD	MOUNT ON POST
90	S05-08	W6-8A	TRAIL CROSSING	MOUNT ON POST
91	S05-09	W6-Q03	ARROW SUPPLEMENTARY PLATE	MOUNT BELOW SIGN S5-07
92	S05-10	W6-8A	TRAIL CROSSING	MOUNT ON POST
93	S05-11	W6-Q03	ARROW SUPPLEMENTARY PLATE	MOUNT BELOW SIGN S5-09
94	S6-01	W6-8A	ROAD AHEAD	MOUNT ON POST
95	S6-02	R1-2A	GIVE WAY	MOUNT ON POST
96	S6-03	R8-2A	SHARED PATH	MOUNT ON POST
97	S6-04	R8-2A	SHARED PATH	MOUNT ON POST
98	S6-05	R1-2A	GIVE WAY	MOUNT ON POST
99	S6-06	W6-8A	STREET NAME	MOUNT ON POST
100	S6-07	W6-8A	ROAD AHEAD	MOUNT ON POST
101	S6-08	W6-Q03	TRAIL CROSSING	MOUNT ON POST
102	S6-09	W8-23	ARROW SUPPLEMENTARY PLATE	MOUNT BELOW SIGN S6-07
103	S6-10	W6-Q03	TRAIL CROSSING	MOUNT ON POST
104	S6-11	W8-23	ARROW SUPPLEMENTARY PLATE	MOUNT BELOW SIGN S6-09
105	S6-12	W8-200N	BIKE CROSSING ON SIDE STREET	MOUNT ON POST
106	S6-13	W6-8A	ROAD AHEAD	MOUNT ON POST
107	S6-14	W6-8A	ROAD AHEAD	MOUNT ON POST
108	S6-15	W6-8A	ROAD AHEAD	MOUNT ON POST
109	S6-16	R1-2A	GIVE WAY	MOUNT ON POST
110	S6-17	R8-2A	SHARED PATH	MOUNT ON POST
111	S6-18	R1-2A	GIVE WAY	MOUNT ON POST
112	S6-19	R8-2A	SHARED PATH	MOUNT ON POST
113	S6-20	W6-8A	STREET NAME	MOUNT ON POST
114	S6-21	W6-Q03	TRAIL CROSSING	MOUNT ON POST
115	S6-22	W8-23	ARROW SUPPLEMENTARY PLATE	MOUNT BELOW SIGN S6-20
116	S6-23	W6-Q03	TRAIL CROSSING	MOUNT ON POST
117	S6-24	W8-23	ARROW SUPPLEMENTARY PLATE	MOUNT BELOW SIGN S6-20
118	S6-25	W6-8A	ROAD AHEAD	MOUNT ON POST
119	S6-26	W6-8A	ROAD AHEAD	MOUNT ON POST
120	S6-27	W6-8A	ROAD AHEAD	MOUNT ON POST
121	S7-01	W6-8A	ROAD AHEAD	MOUNT ON POST
122	S7-02	W6-8A	ROAD AHEAD	MOUNT ON POST
123	S7-03	W6-8A	ROAD AHEAD	MOUNT ON POST
124	S7-04	R1-2A	GIVE WAY	MOUNT ON POST

			1	
SIGN No.	SIGN ID	SIGN CODE	TYPE/DESCRIPTION	DETAILS
125	S7-05	R8-2A	SHARED PATH	MOUNT ON POST
126	S7-06	R1-2A	GIVE WAY	MOUNT ON POST
127	S7-07	R8-2A	SHARED PATH	MOUNT ON POST
128	S7-08	W6-8A	ROAD AHEAD	MOUNT ON POST
129	S7-09	W6-8A	ROAD AHEAD	MOUNT ON POST
130	S7-10	R1-2A	GIVE WAY	MOUNT ON POST
131	S7-11	R8-2A	SHARED PATH	MOUNT ON POST
132	S7-12	R1-2A	GIVE WAY	MOUNT ON POST
133	S7-13	R8-2A	SHARED PATH	MOUNT ON POST
134	S7-14	W6-8A	STREET NAME	MOUNT ON POST
135	S7-15	W6-8A	ROAD AHEAD	MOUNT ON POST
136	S7-16	W6-Q03	TRAIL CROSSING	MOUNT ON POST
137	S7-17	W8-23	ARROW SUPPLEMENTARY PLATE	MOUNT BELOW SIGN S7-15
138	S7-18	W6-Q03	TRAIL CROSSING	MOUNT ON POST
139	S7-19	W8-23	ARROW SUPPLEMENTARY PLATE	MOUNT BELOW SIGN S7-17
140	S7-20	W6-Q03	TRAIL CROSSING	MOUNT ON POST
141	S7-21	W8-244n	AHEAD	MOUNT BELOW SIGN S7-19
142	S7-22	W6-Q03	TRAIL CROSSING	MOUNT ON POST
143	S7-23	W8-244n	AHEAD	MOUNT BELOW SIGN S9-21
144	S8-01	W6-8A	ROAD AHEAD	MOUNT ON POST
145	S8-02	R1-2A	GIVE WAY	MOUNT ON POST
146	S8-03	R1-2A R8-2A	SHARED PATH	MOUNT ON POST
147	S8-04	R1-2A	GIVE WAY	MOUNT ON POST
148	S8-05	R8-2A	SHARED PATH	MOUNT ON POST
149	S8-06	R8-2A	STREET NAME	MOUNT ON POST
150	S8-07	W6-8A	ROAD AHEAD	MOUNT ON POST
151	S8-08	W6-Q03	TRAIL CROSSING	MOUNT ON POST
152	S8-09	W8-23	ARROW SUPPLEMENTARY PLATE	MOUNT BELOW SIGN S8-07
153	S8-10	W6-Q03	TRAIL CROSSING	MOUNT ON POST
154	S8-11	W8-23	ARROW SUPPLEMENTARY PLATE	MOUNT BELOW SIGN S8-09
155	S8-12	W8-200N	BIKE CROSSING ON SIDE STREET	MOUNT ON POST
156	S8-13	W6-8A	ROAD AHEAD	MOUNT ON POST
157	S8-14	R1-2A	GIVE WAY	MOUNT ON POST
158	S8-15	R8-2A	SHARED PATH	MOUNT ON POST
159	S8-16	R1-2A	GIVE WAY	MOUNT ON POST
160	S8-17	R8-2A	SHARED PATH	MOUNT ON POST
161	S8-18		STREET NAME	MOUNT ON POST
162	S8-19	W6-8A	ROAD AHEAD	MOUNT ON POST
163	CO 20		BICYCLE PEDESTRIAN WARNING SIGN	MOUNT ON POST
164	S8-20	W6-9		PIOUNT ON PUST
165	S8-20 S8-21	W6-9 W8-23	ARROW SUPPLEMENTARY PLATE	
			ARROW SUPPLEMENTARY PLATE BICYCLE PEDESTRIAN WARNING SIGN	
166	S8-21	W8-23		MOUNT BELOW SIGN S8-18
166 167	S8-21 S8-22	W8-23 W6-9	BICYCLE PEDESTRIAN WARNING SIGN	MOUNT BELOW SIGN S8-18 MOUNT ON POST
	\$8-21 \$8-22 \$8-23	W8-23 W6-9 W8-23	BICYCLE PEDESTRIAN WARNING SIGN ARROW SUPPLEMENTARY PLATE	MOUNT BELOW SIGN S8-18 MOUNT ON POST MOUNT BELOW SIGN S8-20
167	\$8-21 \$8-22 \$8-23 \$8-24	W8-23 W6-9 W8-23 R5-400R/L	BICYCLE PEDESTRIAN WARNING SIGN ARROW SUPPLEMENTARY PLATE NO STOPPING	MOUNT BELOW SIGN S8-18 MOUNT ON POST MOUNT BELOW SIGN S8-20 MOUNT ON POST MOUNT ON POST
167 168	\$8-21 \$8-22 \$8-23 \$8-24 \$8-25	W8-23 W6-9 W8-23 R5-400R/L R5-400R/L	BICYCLE PEDESTRIAN WARNING SIGN ARROW SUPPLEMENTARY PLATE NO STOPPING NO STOPPING	MOUNT BELOW SIGN S8-18 MOUNT ON POST MOUNT BELOW SIGN S8-20 MOUNT ON POST MOUNT ON POST MOUNT ON POST AT CH240
167 168 169 170	\$8-21 \$8-22 \$8-23 \$8-24 \$8-25	W8-23 W6-9 W8-23 R5-400R/L R5-400R/L D4-1-1 D4-1-1	BICYCLE PEDESTRIAN WARNING SIGN ARROW SUPPLEMENTARY PLATE NO STOPPING NO STOPPING BRIDGE CLOSED BRIDGE CLOSED	MOUNT BELOW SIGN S8-18 MOUNT ON POST MOUNT BELOW SIGN S8-20 MOUNT ON POST MOUNT ON POST MOUNT ON POST AT CH244 MOUNT ON POST AT CH300
167 168 169	\$8-21 \$8-22 \$8-23 \$8-24 \$8-25 -	W8-23 W6-9 W8-23 R5-400R/L R5-400R/L D4-1-1	BICYCLE PEDESTRIAN WARNING SIGN ARROW SUPPLEMENTARY PLATE NO STOPPING NO STOPPING BRIDGE CLOSED BRIDGE CLOSED BRIDGE CLOSED	MOUNT BELOW SIGN S8-18 MOUNT ON POST MOUNT BELOW SIGN S8-20 MOUNT ON POST MOUNT ON POST MOUNT ON POST AT CH24C MOUNT ON POST AT CH30C MOUNT ON POST AT CH370
167 168 169 170 171 172	\$8-21 \$8-22 \$8-23 \$8-24 \$8-25 - - -	W8-23 W6-9 W8-23 R5-400R/L R5-400R/L D4-1-1 D4-1-1 D4-1-1	BICYCLE PEDESTRIAN WARNING SIGN ARROW SUPPLEMENTARY PLATE NO STOPPING NO STOPPING BRIDGE CLOSED BRIDGE CLOSED BRIDGE CLOSED BRIDGE CLOSED BRIDGE CLOSED	MOUNT BELOW SIGN S8-18 MOUNT ON POST MOUNT BELOW SIGN S8-20 MOUNT ON POST MOUNT ON POST MOUNT ON POST AT CH300 MOUNT ON POST AT CH370 MOUNT ON POST AT CH370 MOUNT ON POST AT CH378
167 168 169 170 171 172 173	\$8-21 \$8-22 \$8-23 \$8-24 \$8-25 - -	W8-23 W6-9 W8-23 R5-400R/L R5-400R/L D4-1-1 D4-1-1 D4-1-1 D4-1-1	BICYCLE PEDESTRIAN WARNING SIGN ARROW SUPPLEMENTARY PLATE NO STOPPING NO STOPPING BRIDGE CLOSED	MOUNT BELOW SIGN S8-18 MOUNT ON POST MOUNT BELOW SIGN S8-20 MOUNT ON POST MOUNT ON POST MOUNT ON POST AT CH300 MOUNT ON POST AT CH370 MOUNT ON POST AT CH370 MOUNT ON POST AT CH378 MOUNT ON POST AT CH378
167 168 169 170 171 172 173	\$8-21 \$8-22 \$8-23 \$8-24 \$8-25 - - -	W8-23 W6-9 W8-23 R5-400R/L R5-400R/L D4-1-1 D4-1-1 D4-1-1 D4-1-1 D4-1-1	BICYCLE PEDESTRIAN WARNING SIGN ARROW SUPPLEMENTARY PLATE NO STOPPING NO STOPPING BRIDGE CLOSED	MOUNT BELOW SIGN S8-18 MOUNT ON POST MOUNT BELOW SIGN S8-20 MOUNT ON POST MOUNT ON POST MOUNT ON POST AT CH300 MOUNT ON POST AT CH370 MOUNT ON POST AT CH370 MOUNT ON POST AT CH708
167 168 169 170 171 172 173 174	\$8-21 \$8-22 \$8-23 \$8-24 \$8-25 - - - - -	W8-23 W6-9 W8-23 R5-400R/L R5-400R/L D4-1-1 D4-1-1 D4-1-1 D4-1-1 D4-1-1 D4-1-1 D4-1-1 D4-1-1	BICYCLE PEDESTRIAN WARNING SIGN ARROW SUPPLEMENTARY PLATE NO STOPPING NO STOPPING BRIDGE CLOSED	MOUNT BELOW SIGN S8-18 MOUNT BELOW SIGN S8-20 MOUNT ON POST MOUNT ON POST MOUNT ON POST AT CH370 MOUNT ON POST AT CH370 MOUNT ON POST AT CH370 MOUNT ON POST AT CH708
167 168 169 170 171 172 173 174 175	\$8-21 \$8-22 \$8-23 \$8-24 \$8-25 - - - - - -	W8-23 W6-9 W8-23 R5-400R/L R5-400R/L D4-1-1	BICYCLE PEDESTRIAN WARNING SIGN ARROW SUPPLEMENTARY PLATE NO STOPPING NO STOPPING BRIDGE CLOSED	MOUNT BELOW SIGN S8-18 MOUNT ON POST MOUNT ON POST MOUNT ON POST MOUNT ON POST AT CH370 MOUNT ON POST AT CH370 MOUNT ON POST AT CH370 MOUNT ON POST AT CH708 MOUNT ON POST AT CH7097 MOUNT ON POST AT CH997 MOUNT ON POST AT CH1014
167 168 169 170 171 172 173 174 175 176	\$8-21 \$8-22 \$8-23 \$8-24 \$8-25 - - - - - -	W8-23 W6-9 W8-23 R5-400R/L R5-400R/L D4-1-1	BICYCLE PEDESTRIAN WARNING SIGN ARROW SUPPLEMENTARY PLATE NO STOPPING NO STOPPING BRIDGE CLOSED	MOUNT BELOW SIGN S8-18 MOUNT ON POST MOUNT ON POST MOUNT ON POST MOUNT ON POST AT CH300 MOUNT ON POST AT CH301 MOUNT ON POST AT CH301 MOUNT ON POST AT CH301
167 168 169 170 171 172 173 174 175 176 177	\$8-21 \$8-22 \$8-23 \$8-24 \$8-25 - - - - - - - -	W8-23 W6-9 W8-23 R5-400R/L R5-400R/L D4-1-1	BICYCLE PEDESTRIAN WARNING SIGN ARROW SUPPLEMENTARY PLATE NO STOPPING NO STOPPING BRIDGE CLOSED	MOUNT BELOW SIGN S8-18 MOUNT BELOW SIGN S8-20 MOUNT ON POST MOUNT ON POST MOUNT ON POST AT CH300 MOUNT ON POST AT CH708 MOUNT ON POST AT CH1014
167 168 169 170 171 172 173 174 175 176 177 178	\$8-21 \$8-22 \$8-23 \$8-24 \$8-25 - - - - - - - - -	W8-23 W6-9 W8-23 R5-400R/L R5-400R/L D4-1-1	BICYCLE PEDESTRIAN WARNING SIGN ARROW SUPPLEMENTARY PLATE NO STOPPING NO STOPPING BRIDGE CLOSED	MOUNT BELOW SIGN S8-18 MOUNT ON POST MOUNT ON POST MOUNT ON POST AT CH307 MOUNT ON POST AT CH308 MOUNT ON POST AT CH708 MOUNT ON POST AT CH1014 MOUNT ON POST AT CH1080 MOUNT ON POST AT CH1080 MOUNT ON POST AT CH1080
167 168 169 170 171 172 173 174 175 176 177 178 179	\$8-21 \$8-22 \$8-23 \$8-24 \$8-25 - - - - - - - - - -	W8-23 W6-9 W8-23 R5-400R/L R5-400R/L D4-1-1	BICYCLE PEDESTRIAN WARNING SIGN ARROW SUPPLEMENTARY PLATE NO STOPPING NO STOPPING BRIDGE CLOSED	MOUNT BELOW SIGN S8-18 MOUNT ON POST MOUNT ON POST MOUNT ON POST AT CH307
167 168 169 170 171 172 173 174 175 176 177 178 179 180	\$8-21 \$8-22 \$8-23 \$8-24 \$8-25 - - - - - - - - -	W8-23 W6-9 W8-23 R5-400R/L R5-400R/L D4-1-1	BICYCLE PEDESTRIAN WARNING SIGN ARROW SUPPLEMENTARY PLATE NO STOPPING NO STOPPING BRIDGE CLOSED	MOUNT BELOW SIGN S8-18 MOUNT BELOW SIGN S8-20 MOUNT ON POST MOUNT ON POST MOUNT ON POST AT CH300 MOUNT ON POST AT CH708 MOUNT ON POST AT CH1067 MOUNT ON POST AT CH1067 MOUNT ON POST AT CH1080 MOUNT ON POST AT CH1377
167 168 169 170 171 172 173 174 175 176 177 178 179 180 181	\$8-21 \$8-22 \$8-23 \$8-24 \$8-25 - - - - - - - - - -	W8-23 W6-9 W8-23 R5-400R/L R5-400R/L D4-1-1	BICYCLE PEDESTRIAN WARNING SIGN ARROW SUPPLEMENTARY PLATE NO STOPPING NO STOPPING BRIDGE CLOSED	MOUNT BELOW SIGN S8-18 MOUNT BELOW SIGN S8-20 MOUNT ON POST MOUNT ON POST MOUNT ON POST AT CH300 MOUNT ON POST AT CH708 MOUNT ON POST AT CH1067 MOUNT ON POST AT CH1080 MOUNT ON POST AT CH1370
167 168 169 170 171 172 173 174 175 176 177 178 179 180 181 182 183	\$8-21 \$8-22 \$8-23 \$8-24 \$8-25 - - - - - - - - - - - - - -	W8-23 W6-9 W8-23 R5-400R/L R5-400R/L D4-1-1	BICYCLE PEDESTRIAN WARNING SIGN ARROW SUPPLEMENTARY PLATE NO STOPPING NO STOPPING BRIDGE CLOSED	MOUNT BELOW SIGN S8-18 MOUNT ON POST MOUNT ON POST MOUNT ON POST AT CH307 MOUNT ON POST AT CH420
167 168 169 170 171 172 173 174 175 176 177 178 179 180 181 182 183	\$8-21 \$8-22 \$8-23 \$8-24 \$8-25 - - - - - - - - - - - - - -	W8-23 W6-9 W8-23 R5-400R/L R5-400R/L D4-1-1 D4-1-1	BICYCLE PEDESTRIAN WARNING SIGN ARROW SUPPLEMENTARY PLATE NO STOPPING NO STOPPING BRIDGE CLOSED	MOUNT BELOW SIGN S8-18 MOUNT ON POST MOUNT ON POST MOUNT ON POST AT CH308 MOUNT ON POST AT CH370 MOUNT ON POST AT CH420 MOUNT ON POST AT CH420
167 168 169 170 171 172 173 174 175 176 177 178 179 180 181 182 183	\$8-21 \$8-22 \$8-23 \$8-24 \$8-25 - - - - - - - - - - - - - - - - - -	W8-23 W6-9 W8-23 R5-400R/L R5-400R/L D4-1-1	BICYCLE PEDESTRIAN WARNING SIGN ARROW SUPPLEMENTARY PLATE NO STOPPING NO STOPPING BRIDGE CLOSED	MOUNT BELOW SIGN S8-18 MOUNT ON POST MOUNT BELOW SIGN S8-20 MOUNT ON POST

NORTHERN RIVERS RAIL TRAIL BENTLEY TO LISMORE LISMORE CITY COUNCIL

lismore

A ISSUE FOR TENDER

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NORTHERN RIVERS RAIL TRAIL - BENTLEY TO LISMORE

DRAWING TITLE :

PROPOSED SIGNAGE SCHEDULE

ISSUE FOR TENDER

DEVEL, APPLIC, No. : DATE: 19-07-2023 PROJECT LEADER: TOBY BENNETT DESIGNER: THUY VU DRAFTSPERSON: THUY VU CHECKED: TOBY BENNETT

APPROVED FOR AND ON BEHALF OF BURCHILLS ENGINEERING SOLUTIONS ABN 76 166 942 365

DATUM: AHD FULL SIZE: A1 SCALE : PROJECT No.: BE220677 VERSION: C309